SHEET 1 OF 1

CASE ZC 2023-XX

LAND USE TABLE

ITEM RI-PD (4.293 AC) 18 UNITS MIN. LOT AREA AVG. LOT AREA 5,900 SF MIN FRONT YARD 20 FT MINN REAR YARD 10 FT AND 209 MIN. LOT WIDTH 55 FT (56 FT AVG.) MIN. SIDE YARD 10 FT & 6 FT 5 FT AND 5 FT TOTAL OPEN SPACE (32,511 S.F.) 17.39 % USEABLE OPEN SPACE 23,771 SF (12.71 %) DENSITY 4.19 UNITS/AC

AREA CALCULATIONS

AREA OF DEVELOPMENT NUMBER OF UNITS OPEN SPACE

= 4.293 ACRES (187,003 SF) = (32,511 S.F.) 17.39 %

ROW DEDICATION = 2,112 S.F.



GARAGES AT CORNER LOTS TO BE

FURTHEST FROM THE INTERSECTION

ENGINEER / SURVEYOR

A.N.A. CONSULTANTS, L.L.C.

5000 THOMPSON TERRACE COLLEYVILLE, TEXAS 76034 TEL. (817) 335-9900 FAX (817) 335-9955

CELESTIAL LONE STAR HOMES, LLC

3612 TINSDALE DR FLOWER MOUND, TX 75022 TEL. (469) 502-1567

OWNER / DEVELOPER

ABSTRACT NO. 321, AN ADDITION TO THE CITY OF NORTH RICHLAND HILLS, TARRANT COUNTY, TEXAS.

PREPARED MAY 2024

IN THE COX, WILLIAM SURVEY

GRAPHIC SCALE IN FEET SCALE: 1"= 50"

**ZONING EXHIBIT** 

**ORCHARD WALK ESTATES** EXIST, ZONING "C-2" COMMERCIAL PROP. ZONING "RI-PD RESIDENTIAL INFILL PLANNED DEVELOPMENT" LOTS 1-7, 8X & 9X BLOCK 1 & LOTS 1-11, 12X,13X,14X & 15X BLOCK 2

BEING A REPLAT OF LOT "A" BLOCK 12 SMITHFIELD ACRES ADDITION AND BEING 4.293 ACRES OF LAND 18 RESIDENTIAL LOTS & **6 OPEN SPACE LOTS** 

LEGAL DESCRIPTION BEING A 4,293 ACRE TRACT OF LAND BEING A PORTION OF THE COMMERCIAL TRACT IN BLOCK 12, SMITHFIELD ACRES ADDITION, 2ND

SECTION, AN ADDITION TO THE CITY OF NORTH RICHLAND HILLS AS

SHOWN ON THE PLAT RECORDED IN VOLUME 388/21, PAGE 36, PLAT

STAR HOMES LLC. BY DEEDS RECORDED IN INSTRUMENTS NUMBER

TRACT IS MORE PARTICULARLY DESCRIBED AS FOLLOWS:

BEGINNING OF A CURVE TO THE RIGHT:

30 MINUTES 57 SECONDS W 466.13 FEET;

RECORDS, TARRANT COUNTY, TEXAS:

WITH CAP SET:

WITH CAP SET;

WITH CAP SET:

STATE OF TEXAS TRACT THE FOLLOWING CALLS:

HE SOUTHEASTERLY LINE OF TURNER ROAD;

BEGINNING AND CONTAINING 4.293 ACRES.

D223214155, DEED RECORDS, TARRANT COUNTY, TEXAS.SAID 4.293 ACRE

BEGINNING AT A 5/8" IRON WITH CAP SET AT THE EASTERLY CORNER OF

THE NORTHWESTERLY LINE OF DAVIS BOULEVARD (F.M. 1938) AND THE

SAID COMMERCIAL TRACT, IN THE SOUTHERLY LINE OF TURNER ROAD, IN

THENCE 467.37 FEET WITH THE ARC OF SAID CURVE TO THE RIGHT, A LINE

OF SAID COMMERCIAL TRACT AND THE NORTHWESTERLY LINE OF DAVID.

HAS A RADIUS OF 1,849.86 FEET A CENTRAL ANGLE OF 14 DEGREES 28 MINUTES 33 SECONDS AND A LONG CHORD WHICH BEARS S 32 DEGREES

THENCE S 39 DEGREES 45 MINUTES 14 SECONDS W WITH A LINE OF SAID COMMERCIAL TRACT AND THE NORTHWESTERLY LINE OF DAVID BOULEVARD, 40.20 FEET TO A HIGHWAY MONUMENT FOUND AT THE NORTHEAST CORNER OF A TRACT OF LAND DESCRIBED IN A DEED TO THE STATE OF TEXAS AND RECORDED IN VOLUME 9421, PAGE 2172, DEED

THENCE WITH THE NORTHWESTERLY LINE OF DAVIS BOULEVARD AND THE

S 43 DEGREES SO MINUTES 14 SECONDS W, 291.89 FEET TO A 5/8" IRON

S 39 DEGREES 55 MINUTES 14 SECONDS W, 104.80 FEET TO A 5/8" IRON

S 30 DEGREES 54 MINUTES 14 SECONDS W, 104.66 FEET TO A 5/8" IRON

S 21 DEGREES 04 MINUTES 14 SECONDS W, 85.40 FEET TO A 5/8" IRON WITH CAP SET;

S 01 DEGREES 59 MINUTES 13 SECONDS W, 33.02 FEET TO A 5/8" IRON WITH CAP SET AT THE SOUTHWEST CORNER AT SAID COMMERCIAL TRACT:

THENCE N 42 DEGREES 10 MINUTES 57 SECONDS E WITH THE NORTHWESTERLY LINE OF SAID COMMERCIAL TRACT AND THE SOUTHEASTERLY LINE OF TURNER ROAD, 36.56 FEET TO A 1/2 IRON

THENCE N 58 DEGREES 09 MINUTES 37 SECONDS E WITH THE NORTHWESTERLY LINE OF SAID COMMERCIAL TRACT AND THE SOUTHEASTERLY LINE OF TURNER ROAD 829,77 FEET TO THE POINT OF


THENCE N 12 DEGREES 14 MINUTES 23 SECONDS W WITH THE WESTERLY LINE OF SAID COMMERCIAL TRACT, 463.06 FEET TO A 1/2" IRON FOUND AT THE NORTHWEST CORNER OF SAID COMMERCIAL TRACT AND BEING IN

BOULEVARD TO A 5/8" IRON WITH CAP SET. SAID CURVE TO THE RIGHT

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MICKEY

VICINITY MAP

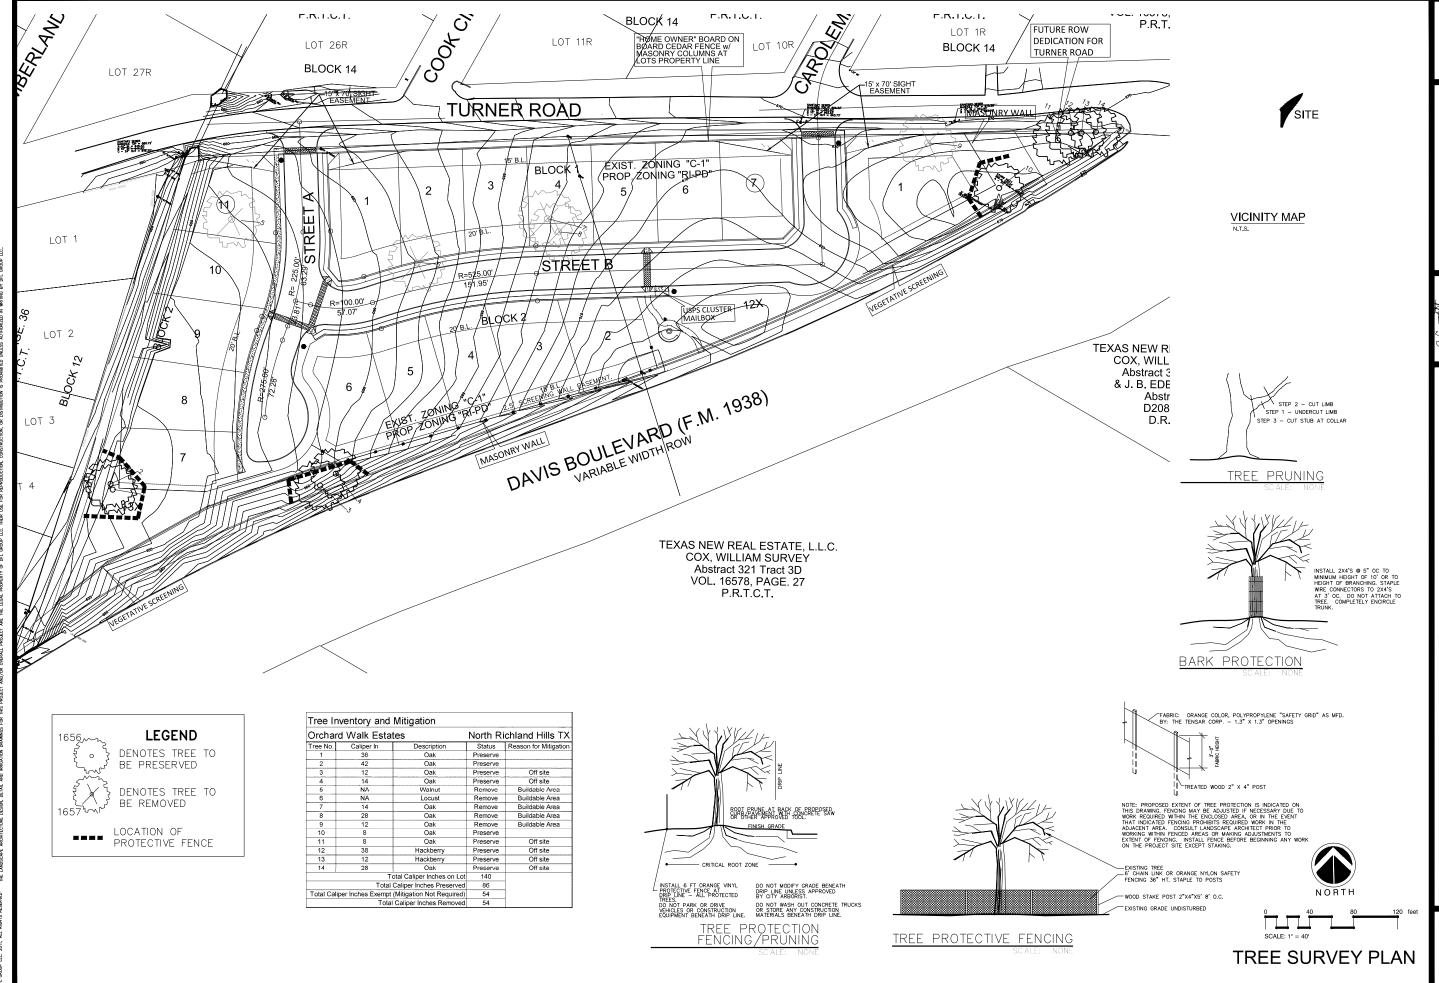

MAY 20, 2024 Drawn By GAC
Checked By GAC Revisions






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ORCHARD WALK ESTATES 8220 TURNER ROAD NORTH RICHLAND HILLS, TEXAS

Sheet No.

T-1

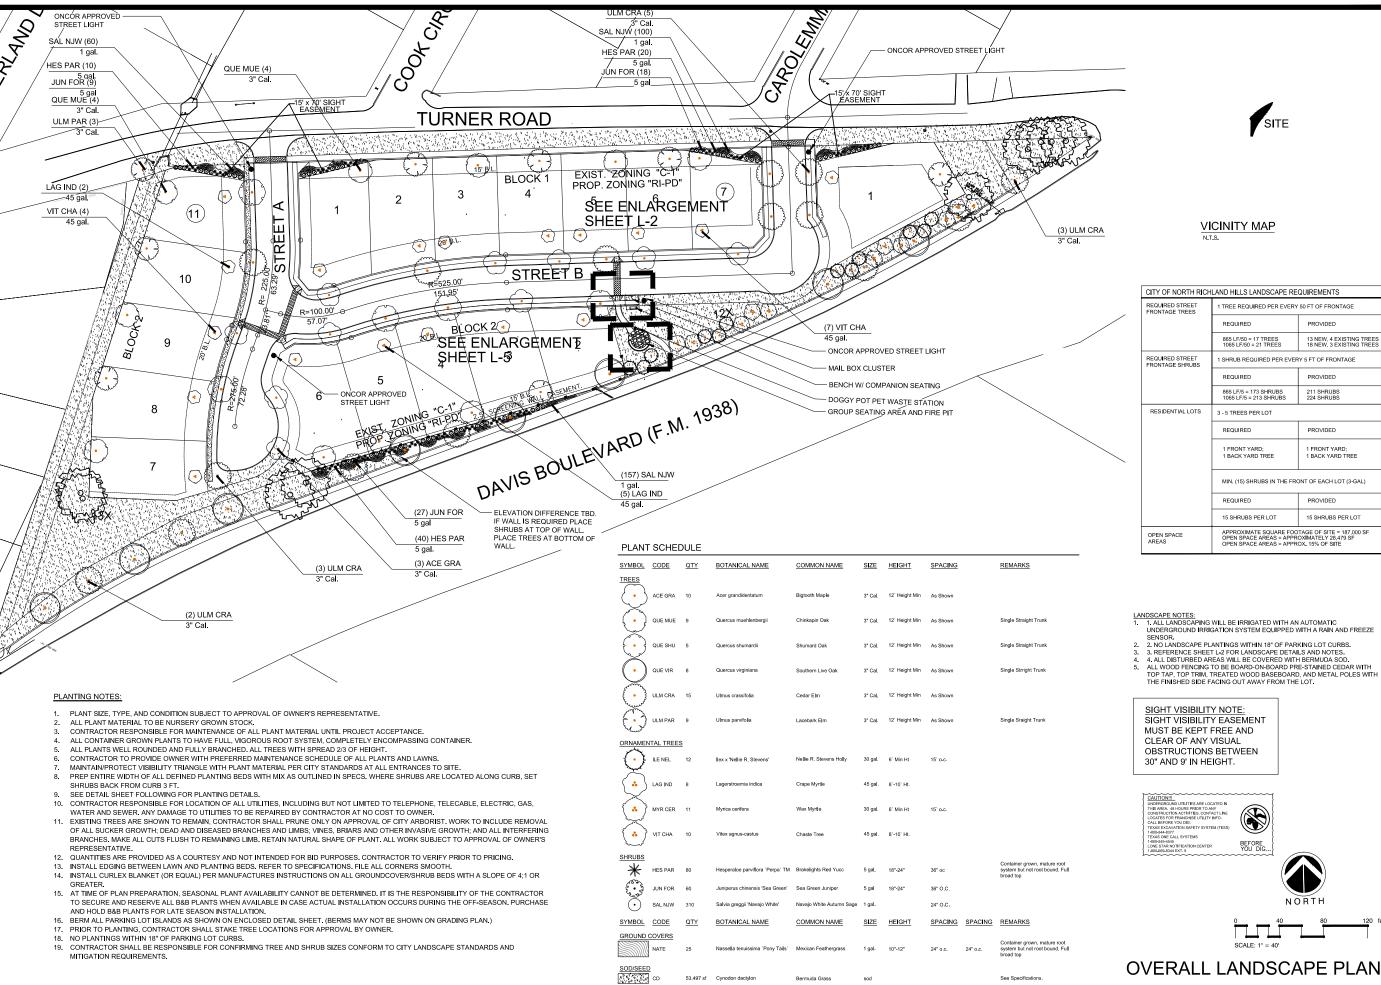

Checked By Revisions



**ESTATES** OAD C. WALK ORCHARD V

**OVERALL LANDSCAPE PLAN** 

VICINITY MAP

865 LF/50 = 17 TREES 1065 LF/50 = 21 TREES

865 LF/5 = 173 SHRUBS 1065 LF/5 = 213 SHRUBS

3 - 5 TREES PER LOT

1 BACK YARD TREE

15 SHRUBS PER LOT

TREE REQUIRED PER EVERY 50 FT OF FRONTAGE

SHRUB REQUIRED PER EVERY 5 FT OF FRONTAGE

MIN. (15) SHRUBS IN THE FRONT OF EACH LOT (3-GAL)

APPROXIMATE SQUARE FOOTAGE OF SITE = 187,000 SF OPEN SPACE AREAS = APPROXIMATELY 28,479 SF OPEN SPACE AREAS = APPROX. 15% OF SITE

13 NEW, 4 EXISTING TREES 18 NEW, 3 EXISTING TREES

N.T.S.

Sheet No.

 Date
 MAY 20, 2024

 Drawn By
 GAC

 Checked By
 GAC

 Revisions
 GAC

FAIN • CUPPETT
LANDSCAPE ARCHITECTS, LLC
1921 MAPLEWOOD DR
WACHTEROOD, 1X 70807
1822 15-9151
PMRS AND DRIP AND LANDSCAPE ARCHITECTTS, LLC



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ORCHARD WALK ESTATES 8220 TURNER ROAD NORTH RICHLAND HILLS, TEXAS

Sheet No.

1.01 DESCRIPTION OF WORK

A. Scope

Bed prep Metal edging

Topoil

Planting Mulching

Related Work Specified Elsewhere

General Requirements - All locations

Section 02740 - Irrigation Trenching Section 02750 - Irrigation Section 02800 - Lawns

1.02 QUALITY ASSURANCE

A. Contractor Qualifications

Minimum of three (3) years experience on projects of similar

B. Reference Standards:

American Joint Committee Of Horticultural Nomenclature: Standardized Plant Names, Second Edition, 1942: American Association Of Nurserymen: American Standard For Nursery Stock, 1973

Substitutions accepted only upon written approval of Landscape Architect and Owner.
 Submit substitutions possessing same characteristics as indicated on plans and specifications.

D. Inspection and Testina

1. The project Owner's representative reserves the right to inspect and tag plants at the place of growth with the Contractor.

Inspection at place of growth does not preclude the right samples and analysis of soil and plant mix. Remove or correct unacceptable soil. Cost of testing by Contractor.

1.03 SUBMITTALS

Submit State and Federal certificates of inspection with invoice. (Only if required by Landscape Architect.)

2. File certificates with Owner's representative prior to

1.04 PRODUCT DELIVERY, STORAGE, & HANDLING

A. Preparation of Delivery

1. Balled & Burlaped (B&B) Plants

a. Dig and prepare for shipment in manner that will not damage roots, branches, shape, and future development after

replanting.
b. Ball with firm, natural ball of soil, wrapped tightly with burlap covering entire ball.

c. Ball size and ratios: conform to American Association of Nurserymen standards unless otherwise shown on plant list.

Pack plant material to protect against climatic & seasonal damage, as well as breakage injuries during transit.

S. Securely cover plant tops with ventilated tarpaulin or convas to minimize wind—whipping and drying in transit.

Pack and ventilate to prevent sweating of plants during

transit. Give special attention to insure prompt delivery and careful handling to point of delivery at job site.

Deliver fertilizer, fertilizer tablets, peat, mulch, soil additives, and amendment materials to site in original, unopened containers, bearing manufacturer's augranteed chemical analysis, name, trade name, trademark, and conformance to State law.

2. Deliver plants with legible identification and size labels on

example plants. Protect during delivery to prevent damage to root ball or

4. Notify Owner's representative of delivery schedule in advance so plant material may be inspected upon arrival at

job site.
5. Deliver plants to job site only when areas are prepared.

Protect roots of plant material from drying or other possible injury with wetted mulch or other acceptable material. Protect from weather. Maintain and protect plant material not to be planted

immediately upon delivery

Do not drop plants. Do not damage ball, trunk, or crown. Lift and handle plants from bottom of container or ball.

E. Planting Season Perform actual planting only when weather and soil conditions are suitable in accordance with

locally acceptable practices.

F. Protection Before excavations are made, take precautionary measures to protect areas trucked over and where soil is temporarily stacked.

1 OF GUARANTEE

A. Guarantee new plant material for one year after acceptance of final installation (ie Final Acceptance of

acceptance of final installation (le final acceptance of project).

B. Make replacement (one per plant) during one year guarantee period at appropriate season with original plant type, size and planting mixture.

C. Repair damage to other plants, lawns, & irrigation caused

during plant replacement at no cost to Owner Use only plant replacements of indicated size and

PART II PRODUCTS

2.01 MATERIALS

Hardy under climatic conditions similar to locality of

True to botanical and common name variety. 2. Irue to botanical and common name variety.
3. Sound, healthy, vigorous, well branched, and densely foliated when in leaf; with healthy well—developed root system.
4. Free from disease, insects, and defects such as knots, sun-scald, windburn, injuries, disfigurement, or obrasions.
5. Conform to measurements after pruning with branches in normal positions.
6. Conform to American Association of Nurserymen tendential values above differently as plant list.

standards unless shown differently on plant list

rrees: Single, straight trunks, unless indicated otherwise Trees with weak, thin trunks not capable of support will

not be accepated. c. All multi—stem trees are to have a minimum of three stems, similar in size and shape, with a spread of approximately 2/3 of the height. All yaupons to be female. Crape myrtle color selection by Landscape Architect.

Nursery grown stock only.

Subject to approval of Landscape Architect.

Seasonal color Annuals in 4" pots or as specified

Perennials in 4" pots, clumps, bulbs as specified

Natural, fertile, friable soils having a textural classification of loam or sandy loam possessing characteristics of soils in vicinity which produce heavy growth of crops, grass, or other

vegetation.

2. Free of subsoil, brush, organic litter, objectionable weeds, clods, shale, stones ¾" diameter or larger, stumps, roots or other material harmful to grading, planting, plant growth, or intenance operations.

3. Presence of vegetative parts of Bermuda grass ( Cynodon dactylon), Johnson grass, nut grass (Cyperus rotundus), and other hard to eradicate weeds or grass will be

Test topsoil (cost by Contractor):

Available nitrogen

Available phosphorus Available potash

Iron Ph: 5.5 to 7.0

Decomposed organic matter: 6-10%

1. Top Dressing Mulch - Shredded cypress or hard wood

, Mulch for soil prep — Shredded pine bark In pre—packaged bags only; bulk shredded material is

D. Peat Moss Commercially available baled peat moss or

1. Stakes for tree support

a. Construction grade yellow pine, stain brown
 b. Size as noted on plans

Padded with rubbed hose to protect tree

Galvanized With galvanized turnbuckle Evenly tighten turnbuckles with plant in vertical position.

Free of oils, acids, alkali, salt, and other substances harmful to plant growth
2. Location: Furnish temporary hoses and connections on

G. Sand Washed builders sand

H. Antidesicant — "Wilt-proof" or equal.

I. Edging - 3/16" X 4" green, new and unused; with

2.02 MIXES

A. Planting Mixture

Existing topsoil - 50%

3. Shredded pine bark - 50%

4. Fertilizer 10:20:10 at 30 lb./1000 SF

B. Planting Mix for Annuals/Perennials

C. Azalea mix: solid peat moss in hole 9" wider than root ball each direction. Plant in solid peat moss and provide mound at base of plant to allow for drainage.

D. Japanese maple, dogwood, camellias: Provide 50/50 peat

PART III - EXECUTION

3.01 UTILITIES — verify location of all utilities prior to initiating construction; repair any damage caused by construction at no cost to owner.

Inspect plants for injury and insect infestation; prune

prior to installation.

B. Inspect site to verify suitable job conditions.

3 03 FIELD MEASUREMENTS

A. Location of all trees and shrubs to staked in the field and approved by Owner's representative prior to installation.

B. Location of all groundcover and seeding limits as shown

3.04 EXCAVATION FOR PLANTING

A. Pits

Shape — Vertical hand scarified sides and flat bottom. Size for trees — 2 feet wider or twice the root ball,

ichever is greater.

Size for shrubs — Size of planting bed as shown on

drawings.

4. Rototill soil mix thoroughly, full depth.

5. NOTE: If beds are proposed beneath drip line of existing tree canopy, pocket prep plants. Do not roto—till beneath

B. Obstructions Below Ground

1. Remove rock or underground obstructions to depth remove rock or underground obstructions to depth isseary to permit planting.

If underground obstructions cannot be removed, notify er's representative for instruction.

C. Excess Soil Dispense of unacceptable or excess soil away from the project site at Contractor's expense.

3.05 PLANTING

Set plants 2" above existing grade to allow for settling.
 Set plants plumb and rigidly braced in position until planting mixture has been tamped solidly around ball.

Apply soil in accordance with standard industry practice

Thoroughly settle by water jetting and tamping soil in 6"

Prepare 3" dish outside root ball after planting.

Thoroughly water all beds and plants.
Stake trees and large shrubs as indicated on plans.
Apply anti-desicant according to manufacturer's

9. Apply commercially manufactured root stimulator as directed by printed instruction.

10. Plant and fertilize bedding plants per trade standards.

11. Apply 3" mulch top dressing

Place in pit of planting mixture that has been hand

tamped prior to placing plant.

2. Place with burlap intact to ground line. Top of ball to be 2" above surrounding soil to allow for settling.

3. Remove binding at top of ball and lay top of burlap

Do not pull wrapping from under ball, but cut all

Do not plant if ball is cracked or broken before or during planting process or if stem or trunk is loose.

6. Backfill with planting mixture in 6" lifts.

C Container Grown Plants

Place in pit on planting mixture that has been hand

amped prior to placing plant. . Cut cans on two sides with an acceptable can cutter,

Do not injure root ball.
3. Carefully remove plants without injury or damage to root balls.
4. Backfill with planting mixture in 6" lifts.

D. Mulching

Cover planting bed evenly with 3" of mulch. Water immediately after mulching. Where mulch has settled, add additional mulch to regain

thickness Hose down planting area with fine spray to wash leaves

D. Pruning

Prune minimum necessary to remove injured twias and branches, dead wood, and succors; remove approximately 1/3 of twig growth as directed by landscape architect; do not cut leaders or other major branches of plant unless

directed by landscape architect Make cuts flush, leaving no stubs.

Paint cuts over 1" diameter with approved tree wound Do not prune evergreens except to remove injured

3.06 EDGING Stake edging alignment with string line prior to installation. Use framing square to insure right angles are

true.

B. Install all edging straight and true as indicated on drawings. Where edging layout is circular in design, maintain true and constant radii as shown.

C. When required on slopes, make vertical cuts

(approximately 6" on center) on bottom of edging to allow bending without crimping edging. D. Install edging so that approximately 1" is exposed on lawn side. Edging should not be visible from bed side after

Align edging with architectural features (ie pavement ioints, windows, columns, wall, etc.) when drawings indicate.

Bend all corners, do not cut corners.

Interlock all pieces with pre-fabricated connectors. Install with all stakes on inside of planting bed. Remove, file off all sharp corners and burrs.

3.07 CLEAN-UP

A. Sweep and wash all paved surfaces.

Remove all planting and construction debris from site, including rocks, trash and all other miscellaneous materials.

A. Contractor responsible for routine, and regular maintenance of site until Final Acceptance is awarded by Owner. Work includes:

Weeding (weekly)

Watering (as required) Pruning

Spraying Fertilizing Mulching

Mowing (weekly)

Provide Owner and Landscape Architect with preferred maintenance schedule in writing. Schedule shall include the above-listed tasks and shall address all frequencies, rates, times, levels, etc.

MAY 20, 2024 GAC GAC Checked By Revisions





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ESTATES TEXAS WALK EST/ R ROAD II AND HILLS, T ORCHARD V 8220 TURNER I NORTH RICHLA

Sheet No.

PLANTING SPECS

PART I - GENERAL

1.01 DESCRIPTION

- A. Work includes turf establishment (sod, hydromulch, etc.) as described on
- B. Make required analysis and material tests for topsoil, fertilizers, and other materials of similar character per current methods of the Association of Official
- C. Grass seed shall conform to tolerances for germination and purity per applicable standards of U.S. Department of Agriculture.
- D. The turf contractor shall have a stand of grass established prior to substantial completion of the project. If this is not possible due to time of year or schedule, he shall maintain and protect the seeded areas until the grass is

PART II - PRODUCTS

2.01 TOPSOIL MATERIAL

- A. Topsoil material (stockpiled, as specified in Specifications) has been saved for use in finish grading. After sitting out all plant growth, rubbish, and stones, use for areas designated to receive grass. If stockpiled topsoil is not sufficient quantity to complete work, furnish acceptable topsoil from another approved source to provide four inches (4") of topsoil for grass greas unless otherwise noted on drawings. Grass areas shall be defined as the graded areas disturbed during
- B. Acceptable topsoil material shall be defined as natural, fertile, agricultural soil, capable of sustaining vigorous plant growth, uniform composition throughout admixture of subsoil, free of stones, lumps, plants, and their roots, sticks, or other extraneous matter; do not deliver while in a frozen or muddy condition.

#### 2.02 FERTILIZER

- A Provide a commercial balanced fertilizer delivered to the job in baas
- B. Fertilizer shall be a grade containing the percentages of plant food elements by weight as specified elsewhere in these specifications.
- C. Availability of various elements shall be per Standards of the Association of Official Agricultural Chemists.

- A. Grass seed shall be of the previous season's crop and the date of analysis shown on each bag shall be within nine (9) months of the time of delivery to the project. When requested by the Owner or Representative, the seeding contractor shall furnish a sample of seed from each bag for testing.
- B. The seed shall comply with all provisions of the U.S. Department of Agriculture as to labeling, purity, and germination.

- A. Dry straw or hay of good quality, free of seeds of competing plants and at
- B. Wood cellulose or cane fiber mulch at a rate of 1,000 pounds per acre when the slope is 3/4:1 and steeper; or,
- C. A combination of good quality dry straw or hay free of seeds of competing plants at a rate of 2 1/2 tons per acre and wood cellulose or cane fiber mulch at a rate of 500 pounds per acre. This combination shall be used when the slope is
- D. Sericea lespedza seed bearing hay at a rate of 3 tons per acre. This mulch may be applied green or air dried, but must contain mature seed.
- E. Manufactured mulch materials, such as soil retention blankets, erosion control netting, or others that may be required on special areas of high water concentration or unstable soils. When these materials are used, follow the manufacturer's recommendations for installation.

Wood cellulose fiber or cane fiber mulch will be applied with hydraulic seeding and fertilizing equipment. All slurry ingredients shall be mixed to form a homogeneous slurry and spray applied within one hour after the mixture is made.

When wood cellulose or cane fiber mulch is used at the 500 pound per acre rate, straw or hay mulch with asphalt emulsion is applied over this to complete the

Wood cellulose or cane fiber mulch at the 1,000 pound per acre rate is used alone where other mulch material will not stick.

Wood cellulose or cane fiber mulch is self anchoring.

PART III - EXECUTION

3.01 RESPONSIBILITY

The site grading contractor will be responsible to stockpile acceptable mounds/berms at the appropriate height and width as defined and shown on the landscaping and/or planting drawings. The topsoil and grass great shall be further defined as any area disturbed during the grading and construction process.

The site grading contractor, shall be responsible to spread the topsoil within all perimeter graded areas and future building areas only.

The site grading contractor shall be responsible for backfilling of all curbed islands and planting mounds/berms. They shall also be responsible for removal of all stones, roots, and raking of all topsoil areas hat are to be seeded and/or planted. It will also be the site grading contractor's responsibility to provide fertilizer, grass seed, and any additional topsoil required and mulching.

- A. Remove stones, roots, rubbish and other deleterious materials from topsoiled areas that are to be seeded.
- B. Immediately prior to sowing seed, scarify ground as necessary; rake until surface is smooth and friable. Sow seed evenly, lightly wood rake into
- C. ground, then roll ground with suitable roller; water thoroughly with fine spray. During any weather, keep lawn watered with sprinklers or other approved methods. Re-seed any areas not doing well or damaged. At intervals as may be required according to seasonal conditions, now and water gross and excute necessary weeding until acceptable and full stand of grass has been obtained.
- D. Provide permanent grass seeding for lawn areas so indicated. Seed in accordance with the following schedule (unless otherwise directed by Owner or
- 2. Sow areas ready for seeding between October 1 and March 1 with Unhulled Common Bermuda at a rate of 90 pounds per acre, and Annual Rye Grass at the rate of 50 pounds per acre.
- 3. Apply fertilizer at a rate of 20/25 pounds per 1,000 square feet.

A. Areas indicated on plans to receive wild flower coverage shall br fine graded, fertilized, and prepared in a manner similar to traditional turf establishment.

B. Area to be hydromulched with seed mix as follows:

15 pounds/acre Ox-Eved Daisy 5 pounds/acre Side Oats Grama 4 pounds/acre
Showy Primrose 0.5 pounds/acre Plains Coreopsis 2 pounds/acre

Black Eyed Susan 2 pounds/acre Indian Blanket 10 pounds/acre Texas Bluebonnet 4 pounds/acre Little Bluestem 4 pounds/acre

- A. All areas to be seeded shall be mulched.

  B. Mulch materials shall be applied uniformly over the seeded area. Mulch shall be straw and shall be at the rate of  $1 \frac{1}{2} - 2$  tons per acre.
- B. Mulch shall be anchored with an emulsified asphalt binder at the rate of 10 gallons per 1,000 square feet.

Provide, at no additional cost to Owner, fencing, railing, wire or other types of protection for topsoiled and seeded areas against trespossing and damage. If lawns are damaged prior to Final Acceptance, treat or replace them as directed. Remove protection when so directed.

Provide maintenance from start of work until Final Acceptance. Maintenance includes watering of lawns, weeding, mowing, edging, repairs of wash-outs and guillies, repairs to protection, and other necessary work of maintenance. Maintain slopes against erosion.

The Owner's representative will designate great to be replanted. Areas on The Owner's representative will designate areas to be replanted. Areas on which a stand of growing grass is not present in a reasonable length of time, (Bermuda grass seed should be germinating in 6–8 days) shall be prepared, reseeded and remulched, as specified for original planting at no additional cost to Owner. A stand shall be defined as live plants from seed occurring at a rate of not less than 1,000 growing plants per square foot. Replanting required because of faulty operations or negligence on the part of the Contractor shall be performed without cost to Owner. 3.08 FINAL CLEAN-UP

- A. At time of final inspection of work, and before final acceptance, clean paved areas that are soiled or stained by operations of work of this section. Clean by sweeping or washing, and remove all defacements or stains.
- B. Remove construction equipment, excess material and tools. Cart away from site any debris resulting from work of this section and dispose of as directed.

PART I - GENERAL

1.01 DESCRIPTION

A. Work Included

Sod bed preparation

Fertilizing

Fertilizing
 Sodding
 Miscellaneous management practices

B. Related Work Specified Elsewhere

Finish Grading, Section 02800
 Lawns and Grasses, Section 02930

1.02 REFERENCE STANDARDS

A. Standardized Plant Names

American Joint Committee of Horticultural Nomenclature, Second Edition, 1942.

B. Texas Highway Department — Standard Specifications for Construction, Item 164, Seeding for Erosion Control.

A. Vendors Certification That Sod Meets Texas State Sod Law

Include labeling requirements.
 Include purity and type.

1.04 PRODUCT DELIVERY, STORAGE AND HANDLING

1. Previous season's crop with date of analysis on each

bag. 2. Furnish and deliver each variety in separate bags or

Sod to be cut no more than three days before delivery.

Unopened bags labeled with the analysis.
 Conform to Texas Fertilizer Law.

Only during suitable weather and soil conditions.
 As specifically authorized by the Owner's Representative

B. Schedule - Only after all other construction is complete.

C. Protect and Maintain Sodded Areas

From traffic and all other use.
 Until sodding is complete and accepted.

PART II - PRODUCTS

2.01 MATERIALS

- Sod: As specified on drawings, weed, insect, and disease free having a minimum of 1 inch of topsoil attached to the roots and cut no more than three days prior to
- installation.

  2. The sod shall be cut in strips of at least 1/2 sq. yd. and not more than 1 sq. yd. Sod shall be cut into strips not less than 12" in width or more than 9' in length. At the time of harvest, the top growth shall not exceed 3" in length.
  3. All sod shall conform to the laws of the State and shall be obtained from sources meeting the approval of the Department of Agriculture, Division of Entomology.

Uniform in composition, free flowing.
 Suitable for application in approved equipment.
 Analysis of 16-20-0, 16-8-8 or as directed.

C. Water:

1. Free of oil, acid, alkali, salts or other substances harmful to growth of grasses.

3.01 SOD BED PREPARATION

A. Cultivate to a depth of four (4") inches by disking and tilling with a power tiller.

B. Clear surfaces of all materials:

Stumps, stones, and other objects larger than one inch

Roots, brush, wire, stakes, etc.
Any objects that may interfere with sodding or maintenance.

Remove soil clods larger than one inch (1").
 Grade areas to smooth, even surface, removing ridges and filling depressions. Final grade to be below finish grade of curbing and edging as shown on details. All grades shall meet approval of Owner's Representative before sodding.

A. Soddina:

Lightly water prepared grade, lay sod with staggered joints and with edges touching. Topdress with topsoil at edges if necessary to provide smooth surface. On slopes of 2 to 1 and greater, fasten sod in place with wood pegs (two each piece) or other approved method. Sod damaged by storage or during installation shall be rejected. Following settlina. tondress with screened, approved topsoil.

settling, topdress with screened, approved topsoil.

2. Water and fertilize at 5 lbs. per 1,000 sq. ft. 3. Sod shall not be placed during a drought, nor during periods when sod is not normally placed in the area, and shall not be placed on frozen ground. No dry or frozen sod

is acceptable.

4. The contractor shall keep all keep all sodded areas moist and growing until Final Acceptance. All areas shall be maintained in an acceptable condition until acceptance by Owner.

B. Rolling:

1. After placing sod, roll with a hand roller, weighing not more than 100 lbs. per foot of width, in two directions. Eliminate all air pockets; finished surface should be free

3.05 MAINTENANCE AND MANAGEMENT

of excessive undulations.

A. Includes protection, replanting, maintaining grades, repair of erosion damage. Also includes weekly mowing at 1 1/2" height until final acceptance.

B. Resodding:

Resod damaged or unacceptable areas. Ruts, ridges, and other surface irregularities shall be rected.

GAC GAC Checked By Revisions

MAY 20, 2024





TEXAS ESTATES WALK EST, ROAD AND HILLS, T ORCHARD V 8220 TURNER I NORTH RICHLA

Sheet No.

-4

**TURF SPECS** 

**CLUSTER MAILBOXES** 

3" FLUTED TRAFFIC SIGNS BY BRANDON INDUSTRIES

ONCOR APPROVED STREET LIGHT





VICTOR STANLEY BENCHES


VICTOR STANLEY
TRASH RECEPTACLES

VICTOR STANLEY BIKE RACK



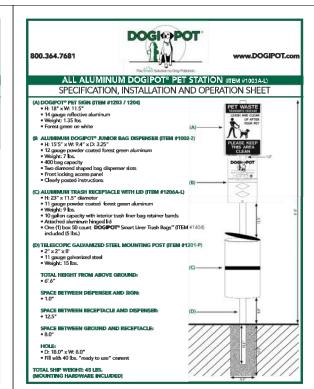

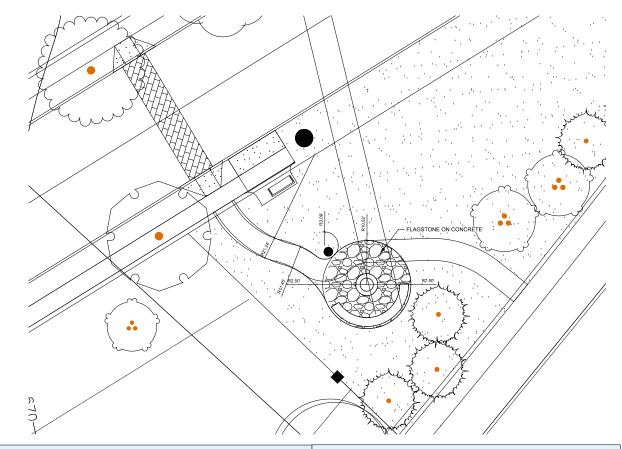

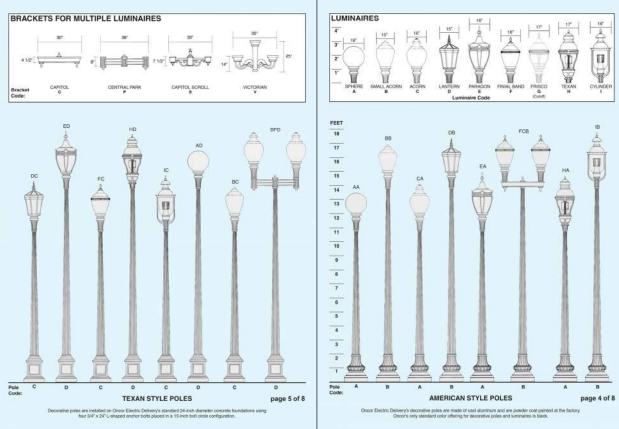

TEXAS STYLE BASE C

LUMINARIES B

SITE AMENITIES

Date MAY 20, 2024
Drawn By GAC
Checked By GAC
Revisions

FAIN • CUPPETT
LANDSCAPE ARCHITECTS, LLC
1921 MAPLEWOOD DR
WEATHERFORD, IT 7, 1982 MEATHERFORD TO 882-215-9151
MARCH ARMSON LANDSCAPE MORPHORE - 882-215-9151




IN THE ELECTRONIC DOWNING THE BY BELLEASID WORTH THE AUTHORITY OF GREEG CLIPPETT.

THE THE ELECTRONIC ENROWING THE WAS RELEASED WORTH THE PROSPRENCY THE THE STREAM THE THE THE STREAM THE

ORCHARD WALK ESTATES 8220 TURNER ROAD NORTH RICHLAND HILLS, TEXAS

Sheet No.

L-5

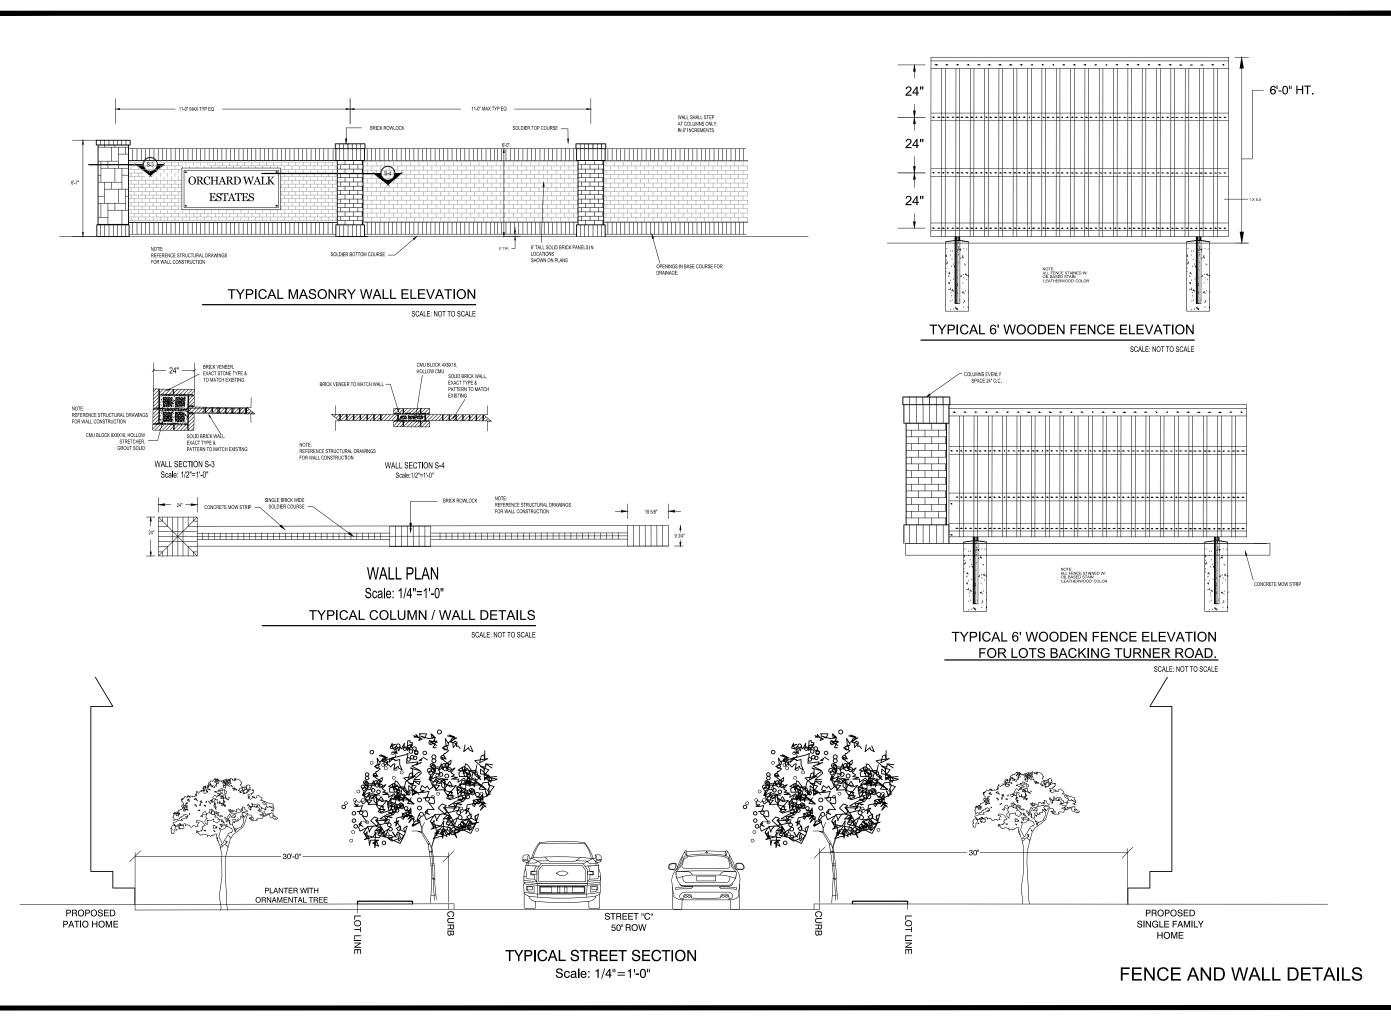

Date MAY 20, 2024
Drawn By GAC
Checked By GAC
Revisions

FAIN • CUPPETT

IANDSCAPE ARCHITECTS, LLC

1921 MAPLEWOOD DR

WEATHER FOOD, IX 70687

WEATHER FOOD, IX



THE BLEFTRONIC DRAWNOR BILE IS RELEASED MOLEN HE ALTHOUGHT OF GREG CLEPPETT.

BLET THE STETCHED PROWNED, LEE AND RESERVED AND RESERVED

ORCHARD WALK ESTATES 8220 TURNER ROAD

Sheet No.

L-6

## DOWEL TO EXISTING, BASE BID

SCALE: NOT TO SCALE 1/2" THICK PREMOLDED EXPANSION JOINTS, SEE -- 3,000 PSI 5" THICK W/ - #4 SMOOTH DOWELS DETAIL ABOVE. MEDIUM BROOM FINISH 8'-0" TYPICAL, REFER TO PLAN SHEETS #3 BARS 18" OCEW 1-1/2" FROM FINISH GRADE SIDEWALK DETAIL

NOTE: ALL EXPANSION AND SAWN/TOOLED JOINTS TO BE FIELD APPROVED. SAWN/TOOLED JOINTS SHALL BE PLACED AT 8' O.C. OR MATCHING ABUTTING

2% MIN CROSS SLOPE AND 5% MAXIMUM WALKWAY GRADE.


#4'S AT IO" OCEW. ALT HOOK FOR 'L' BAR. 2" BATTER-8" X 12" CONT. GRANULAR BACKFILL WRAPPED IN FILTER FABRIC. 2" D PVC WEEPS @ 10'0C. SCREEN ON BACK SIDE OF WALL. " MAX MORTAR JOINT MIN STONE SIZE: 8"T 3'-0" X 12"D X 16"L CUT MILLSAP STONE, STACKED W/2" BATTER COMPACTED BASE 95% STANDARD PROCTOR CONCRETE FOOTING SEATWALL DETAIL, TYP.

18" LEUDARS LIMESTONE CAP

SCALE: 3/4" = 1'-0"

SCALE: NOT TO SCALE

REFER TO PLAN BELOW FOR JOINT LOCATIONS.

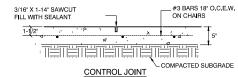

EXPANSION JOINTS AT ALL POINTS OF INTERSECTION OF CURVE. REFER TO SHEET L1.6 FOR RECOMMENDED LOCATIONS




CONT. 6" DEEP X 24" WIDE CONCRETE MOW STRIP. (2) #3

BARS CONTINUOUS AND TIED

TO THE COLUMN FOOTER BASE. MOW STRIP DETAIL SCALE: NOT TO SCALE


## **CONCRETE JOINTS**

SCALE: 1" = 1'-0"

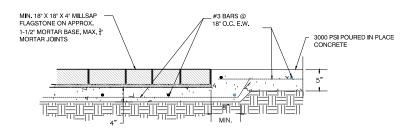


## STONE PAVING INSET

SCALE: 1" = 1'-0"

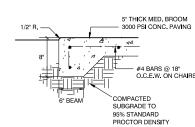


## **BENCH PAD** BASE BID

SCALE: NOT TO SCALE

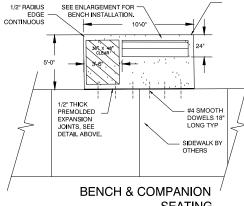

SEATING

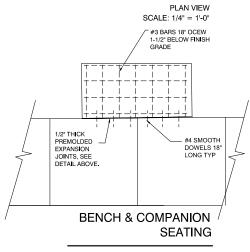

PLAN VIEW SCALE: 1/4" = 1'-0"



ORCHARD WALK ESTATES 8220 TURNER ROAD NORTH RICHLAND HILLS, TEXAS

Sheet No.

L-7

SHEET 1 OF 1

A. N. A. JOB NUMBER 230580

CASE ZC 2023-XX

GARAGES AT CORNER LOTS TO BE FURTHEST FROM THE INTERSECTION

TEXAS NEW REAL ESTÂTE, L'L. COX, WILLIAM SURVEY

FENCE EXHIBIT LEGEND

Masonry screening wall

VICINITY MAP

MICKEY

AREA CALCULATIONS Wood fence AREA OF DEVELOPMENT = 4.293 ACRES (187,003 SF) NUMBER OF UNITS = (32,511 S.F.) 17.39 % OPEN SPACE ROW DEDICATION = 2,112 S.F. FUTURE ROW DEDICATION FOR TURNER ROAD MASONRY WALL EXIST. ZONING "C-BLOCK ' PROP. ZONING "RI-PD (7) 5317 S.F. 259.94' N58°10'42"E STREET B DAVIS BOULEVARD (F.M. 1938)

ENGINEER / SURVEYOR

A.N.A. CONSULTANTS, L.L.C.

5000 THOMPSON TERRACE COLLEYVILLE, TEXAS 76034 TEL. (817) 335-9900 FAX (817) 335-9955 OWNER / DEVELOPER
CELESTIAL LONE STAR HOMES, LLC

3612 TINSDALE DR FLOWER MOUND, TX 75022 TEL. (469) 502-1567

LAND USE TABLE

10 FT AND 209

10 FT & 6 FT

RI-PD (4.293 AC) 18 UNITS

55 FT (56 FT AVG.)

(32,511 S.F.) 17.39 %

23,771 SF (12.71 %)

5 FT AND 5 FT

4.19 UNITS/AC

5,900 SF

20 FT

ITEM

MIN. LOT AREA

AVG. LOT AREA

MIN FRONT YARD

MINN REAR YARD

MIN. LOT WIDTH

MIN. SIDE YARD

DENSITY

TOTAL OPEN SPACE

USEABLE OPEN SPACE

BEING A 4,293 ACRE TRACT OF LAND BEING A PORTION OF THE COMMERCIAL TRACT IN BLOCK 12, SMITHFIELD ACRES ADDITION, 2ND SECTION, AN ADDITION TO THE CITY OF NORTH RICHLAND HILLS AS SHOWN ON THE PLAT RECORDED IN VOLUME 388/21, PAGE 36, PLAT RECORDS, TARRANT COUNTY, TEXAS, AS CONVEYED TO CELESTIAL LONE STAR HOMES LLC, BY DEEDS RECORDED IN INSTRUMENTS NUMBER D223214155, DEED RECORDS, TARRANT COUNTY, TEXAS.SAID 4.293 ACRE TRACT IS MORE PARTICULARLY DESCRIBED AS FOLLOWS:

BEGINNING AT A 5/8\* IRON WITH CAP SET AT THE EASTERLY CORNER OF

LEGAL DESCRIPTION

BEGINNING AT A 5/8" IRON WITH CAP SET AT THE EASTERLY CORNER OF SAID COMMERCIAL TRACT, IN THE SOUTHERLY LINE OF TURNER ROAD, IN THE NORTHWESTERLY LINE OF DAVIS BOULEVARD (F.M. 1938) AND THE BEGINNING OF A CURVE TO THE RIGHT:

THENCE 467.37 FEET WITH THE ARC OF SAID CURVE TO THE RIGHT, A LINE OF SAID COMMERCIAL TRACT AND THE NORTHWESTERLY LINE OF DAVID BOULEVARD TO A 5/8" IRON WITH CAP SET. SAID CURVE TO THE RIGHT HAS A RADIUS OF 1,849.86 FEET A CENTRAL ANGLE OF 14 DEGREES 28 MINUTES 33 SECONDS AND A LONG CHORD WHICH BEARS S 32 DEGREES 30 MINUTES 57 SECONDS W 466.13 FEET;

THENCE S 39 DEGREES 45 MINUTES 14 SECONDS W WITH A LINE OF SAID COMMERCIAL TRACT AND THE NORTHWESTERLY LINE OF DAVID BOULEVARD, 40.20 FEET TO A HIGHWAY MONUMENT FOUND AT THE NORTHEAST CORNER OF A TRACT OF LAND DESCRIBED IN A DEED TO THE STATE OF TEXAS AND RECORDED IN VOLUME 9421, PAGE 2172, DEED RECORDS, TARRANT COUNTY, TEXAS;

THENCE WITH THE NORTHWESTERLY LINE OF DAVIS BOULEVARD AND THE STATE OF TEXAS TRACT THE FOLLOWING CALLS:

S 43 DEGREES SO MINUTES 14 SECONDS W, 291.89 FEET TO A 5/8" IRON WITH CAP SET;

S 39 DEGREES 55 MINUTES 14 SECONDS W, 104.80 FEET TO A 5/8" IRON WITH CAP SET;

S 30 DEGREES 54 MINUTES 14 SECONDS W, 104.66 FEET TO A 5/8" IRON WITH CAP SET;

S 21 DEGREES 04 MINUTES 14 SECONDS W, 85.40 FEET TO A 5/8" IRON WITH CAP SET;

S 01 DEGREES 59 MINUTES 13 SECONDS W, 33.02 FEET TO A 5/8" IRON WITH CAP SET AT THE SOUTHWEST CORNER AT SAID COMMERCIAL TRACT:

THENCE N 12 DEGREES 14 MINUTES 23 SECONDS W WITH THE WESTERLY LINE OF SAID COMMERCIAL TRACT, 463,06 FEET TO A 1/2" IRON FOUND AT THE NORTHWEST CORNER OF SAID COMMERCIAL TRACT AND BEING IN THE SOUTHEASTERLY LINE OF TURNER ROAD;

THENCE N 42 DEGREES 10 MINUTES 57 SECONDS E WITH THE NORTHWESTERLY LINE OF SAID COMMERCIAL TRACT AND THE SOUTHEASTERLY LINE OF TURNER ROAD, 36.56 FEET TO A 1/2 IRON FOUND:

THENCE N 58 DEGREES 09 MINUTES 37 SECONDS E WITH THE NORTHWESTERLY LINE OF SAID COMMERCIAL TRACT AND THE SOUTHEASTERLY LINE OF TURNER ROAD 829.77 FEET TO THE POINT OF BEGINNING AND CONTAINING 4.293 ACRES.



50 100

GRAPHIC SCALE IN FEET

SCALE: 1"= 50'

### **ZONING EXHIBIT**

# **ORCHARD WALK ESTATES**

EXIST. ZONING "C-2" COMMERCIAL PROP. ZONING "RI-PD RESIDENTIAL INFILL PLANNED DEVELOPMENT"

LOTS 1-7, 8X & 9X BLOCK 1 &
LOTS 1-11, 12X,13X,14X & 15X BLOCK 2
BEING A REPLAT OF LOT "A" BLOCK 12
SMITHFIELD ACRES ADDITION
AND BEING 4.293 ACRES OF LAND
18 RESIDENTIAL LOTS &

6 OPEN SPACE LOTS IN THE COX, WILLIAM SURVEY

ABSTRACT NO. 321, AN ADDITION TO THE CITY OF NORTH RICHLAND HILLS, TARRANT COUNTY, TEXAS.

PREPARED MAY 2024

721/2024 17230580:Turner [

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LLS,









