

CONTROL POINT:

THE BEARINGS AND DISTANCES SHOWN HEREON AREA BASED ON A LOCAL COORDINATE SYSTEM BASED ON NADB3, TEXAS NORTH CENTRAL ZONE 4202, SCALED FROM GRID TO SURFACE AT N.7,016,673.76 AND E.2,370,326.03 USING A COMBINED SCALE FACTOR OF 1.001523839, DERIVED FROM GPS RTK OBSERVATIONS USING THE NORTH TEXAS VRS NETWORK(MAINTAINED BY

MENU BOARD NOTE:

THE MENU BOARD WILL NOT BE AN ORDER BOARD CONTAINING A SPEAKER.





VICINITY MAP (N.T.S.)

	EXISTING LEGEND					
	1/2" IR FOUND	n	IRRIGATION CONTROL VALVE			
0	1/2" IR SET	•	BUSH (GENERAL)			
0	STORM DRAIN MH.	•	INLET RIM			
0	BOLLARD POST	0	GAS METER			
*	LIGHT POLE	Ě.	HANDICAP SPACE			
S	SAN. SEW. MH.	— они—	OVERHEAD UTILITY LINE			
b40	IRRIGATION VALVE	—×—	IRON FENCE			
ø ø	FIRE HYDRANT POWER POLE		FIRE LANE STRIPE			
۰	GUY WIRE		STONE RET. WALL			
() Ift	TELEPHONE MARKER TELEPHONE PULL BOX		CONC. RET. WALL			

S	ITE LEGEND
CONCRETE CURB SAW-CUT LINE FIRE LANE	
STRIPING	V///////
PARKING SPACES MONUMENT/PYLON SIGN WHEEL STOPS HANDICAP LOGO HANDICAP SIGN RAMP BOLLARD CLEARANCE BAR BIKE RACK	∑ — &
SIGN TRAFFIC ARROW GREASE TRAP DOMESTIC WATER METER	⇒ •• ••
IRRIGATION METER GAS METER TRANSFORMER	

SITE DATA	SUMMARY TABLE
GROSS LOT AREA NET LOT AREA NET LOT AREA EXISTING ZONING PROPOSED ZONING EXISTING LAND USE BUILDING AREA BUILDING HEIGHT (STORY) LOT COVERAGE FLOOR AREA RATIO PARKING REQUIREMENTS TOTAL PARKING REQUIRED	31,473 S.F. (0,7225 ACER) 31,473 S.F. (0,7225 ACER) 31,473 S.F. (0,7225 ACER) NR-PD UNDER C-1 NR-PD UNDER C-1 DUTCH BROS COFFEE 871 S.F. 24-0" (1 STORY) 2,77 % 0,0277 1 SPACE PER 100 G.F.A 9
TOTAL PARKING PROVIDED HANDICAP PARKING REQUIRED HANDICAP PARKING PROVIDED BUILDING CODE CONSTRUCTION TYPE IMPERVIOUS AREA	13 1 2018 IBC V-B 21,285.73 (67.63%)
PERVIOUS AREA	10 187 27 (32 37%)

FLOOD PLAIN NOTE


ACCORDING TO FLOOD INSURANCE RATE MAP (FIRM) NUMBER 48439C0315L, DATED 03/21/2019, PREPARED BY THE FEDERAL EMERGENCY MANAGEMENT AGENCY (FEMA) FOR TARRANT COUNTY, TEXAS AND INCORPORATED AREAS, THE SUBJECT PROPERTY LIES ZONE "X".

DATE | PROJECT 10/23/20 057-20 DESIGN DRAWN AY ZC

SHEET#

C-3.0

SUP CASE No. 2020-09

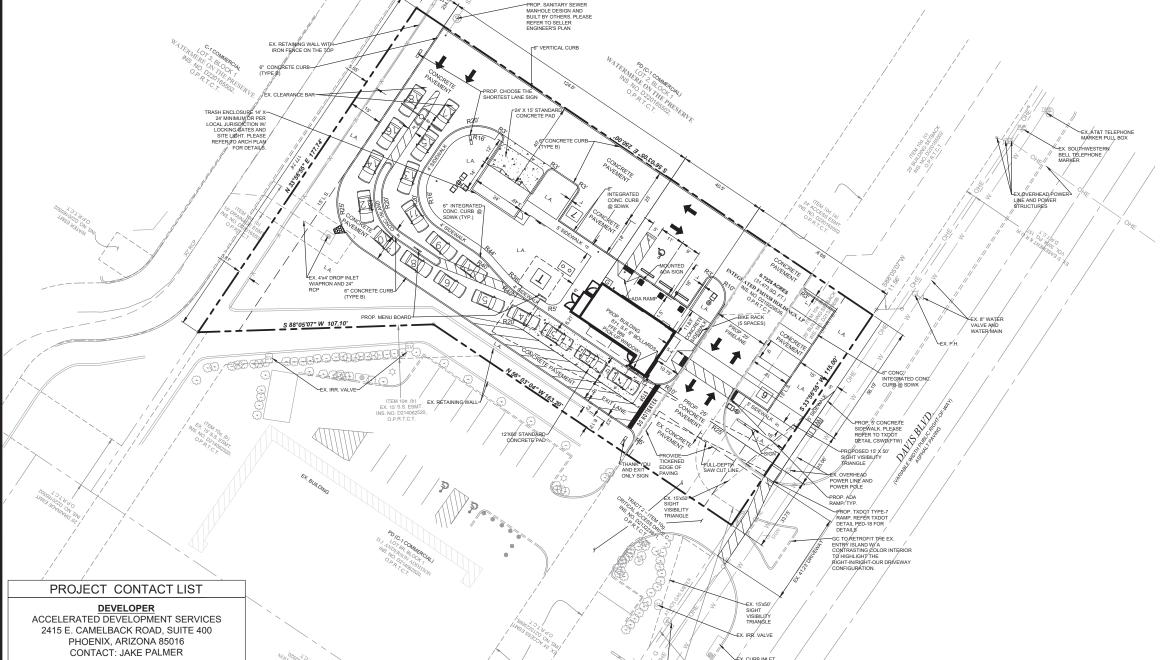

UTILITIES. IF EXISTING UNDERGROUND UTILITIES ARE DAMAGED, THE CONTRACTOR WILL BE RESPONSIBLE FOR THE COST OF

UTILITIES. IF EXISTING UNDERGROUND UTILITIES ARE DAMAGED, THE CONTRACTOR WILL BE RESPONSIBLE FOR THE COST OF REPAIRING THE UTILITY.

WHERE EXISTING UTILITIES OR SERVICE LINES ARE CUT, BROKEN OR DAMAGED, THE CONTRACTOR SHALL REPLACE OR REPAIR THE UTILITIES OR SERVICE LINES WITH THE SAME TYPE OF ORIGINAL MATERIAL AND CONSTRUCTION, OR BETTER, UNLESS OTHERWISE SHOWN OR NOTED ON THE PLANS, AT HIS OWN COST AND EXPENSE. THE CONTRACTOR SHALL IMMEDIATELY NOTIFY THE ENGINEER AT ONCE OF ANY CONFLICTS WITH UTILITIES.

ALL EXCAVATIONS, TRENCHING AND SHORTING OPERATIONS SHALL COMPLY WITH THE REQUIREMENTS OF THE U. S. DEPARTMENT OF LABOR, OSHA, CONSTRUCTION SAFETY AND HEALTH REGULATIONS AND ANY AMENDMENTS THERETO.

THE CONTRACTOR SHALL RESTORE ALL AREAS DISTURBED BY CONSTRUCTION TO ORIGINAL CONDITION OR BETTER, RESTORED AREAS IN CLUBE BILL ARE NOT LIMITED. TO TEPENCY BRACKELI. SIDES SLOPES ERVICES DRAWAGE DITCHES DRIVEWAYS, PRIVATE

AREAS INCLUDE, BUT ARE NOT LIMITED TO TRENCH BACKFILL, SIDE SLOPES, FENCES, DRAINAGE DITCHES, DRIVEWAYS, PRIVATE YARDS AND ROADWAYS.

ANY CHANGES NEEDED AFTER CONSTRUCTION PLANS HAVE BEEN RELEASED, SHALL BE APPROVED BY THE CITY ENGINEER. THESE ANY CHANGES NEEDED AF LIFK CONSTRUCTION PLANS RAVE BEEN RELEASED, SHALL BE APPROVED BY THE CITY ENGINEER. THES
CHANGES MUST BE RECEIVED IN WRITING.
 THE CONTRACTOR SHALL PROVIDE "RED LINED" MARKED PRINTS TO THE ENGINEER PRIOR TO FINAL INSPECTION INDICATING ALL
CONSTRUCTION WHICH DEVIATED FROM THE PLANS OR WAS CONSTRUCTED IN ADDITION TO THAT INDICATED ON THE PLANS.
 ALL CURB RADII TO BE 10" OR 2" UNLESS OTHERWISE NOTED ON THE SITE PLAN.

ARMET DAVIS NEWLOVE & ASSOCIATES

1330 OLYMPIC BLVD

SANTA MONICA, CA 90404

CONTACT: PAUL DEPPER

TEL: 310-452-5533 X 203 EMAIL: DEPPE @ ADNARCH.COM

SPOONER & ASSOCIATED 309 BYERS STREET, SUITE 100

EULESS, TX 76039

CONTACT: ERIC SPOONER

TEL: 817-312-4405

EMAIL: ESPOONER@SPOONERSURVEYORS.COM




TRIANGLE ENGINEERING LLC







Know what's **below**. Call before you dig.


PLAN SITE

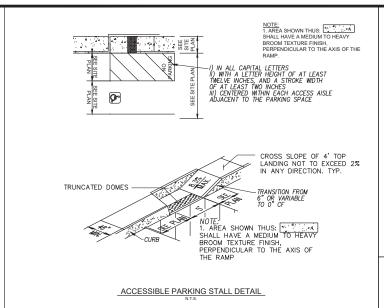

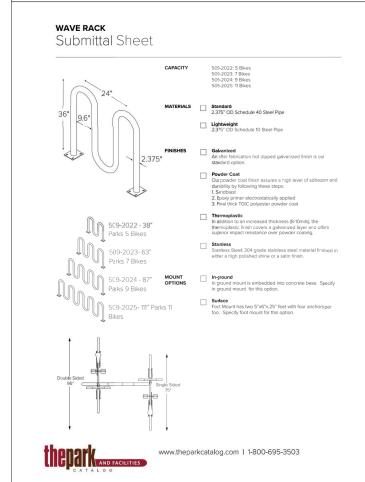

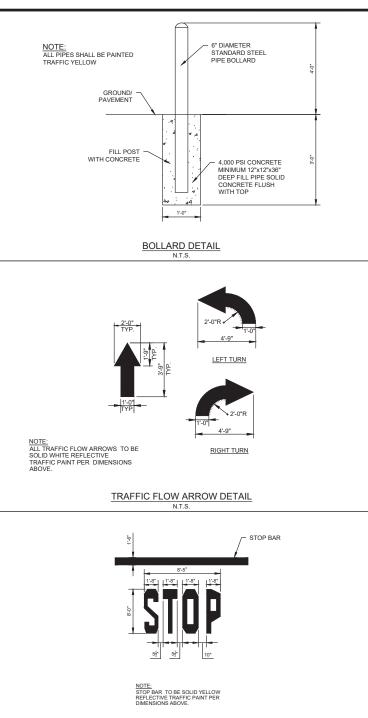

STOP BAR DETAIL N.T.S.

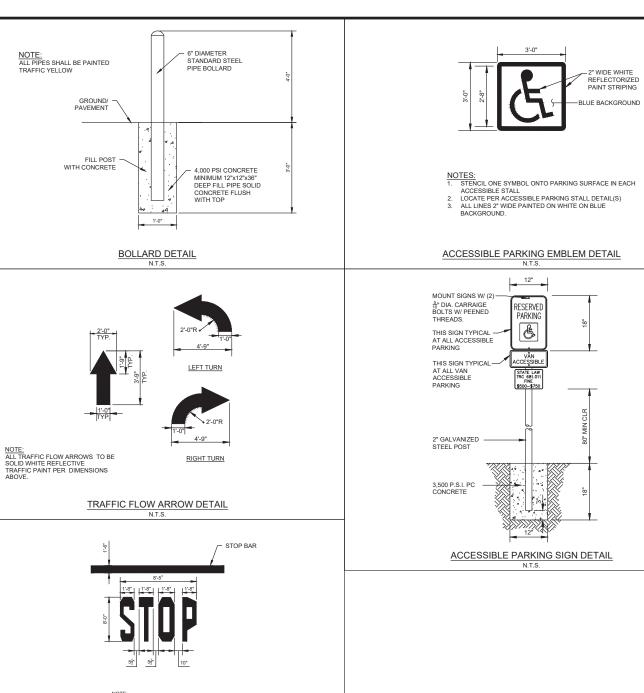







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	DESCRIPTION	SITE PLAN SUBMITTAL	PRELIM ENG. PLANS 1ST SUBMITTAL	1st TXDOT Submittal	PRELIM ENGR. PLANS 2ND SUBMITTAL	PRELIM. ENGR PLANS 3RD SUBMITTAL	
	DATE	10/23/20	11/04/20	12/22/20	02/02/21	03/12/2021	





Know what's **below.**Call before you dig.

SITE DETAILS


DUTCH BROS COFFEE

DAVIS BLVD & PRECINCT LINE RD
CITY OF N. RICHLAND HILLS
TARRANT COUNTY, TEXAS 76182

DATE PROJECT 10/23/20 057-20 DESIGN DRAWN
AY ZC

SHEET#

C-3.1

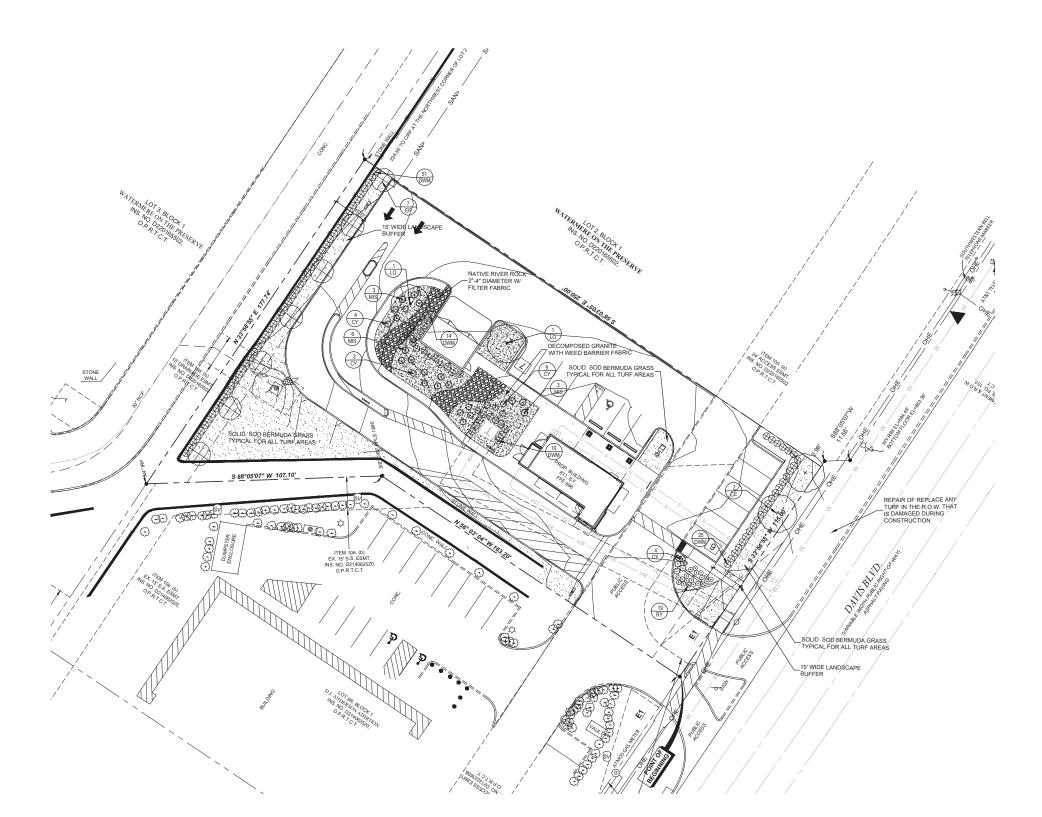

GENERAL LAWN NOTES

- FINE GRADE AREAS TO ACHIEVE FINAL CONTOURS INDICATED ON CIVIL PLANS.
- ADJUST CONTOURS TO ACHIEVE POSITIVE DRAINAGE AWAY FROM BUILDINGS. PROVIDE UNIFORM ROUNDING AT TOP AND BOTTOM OF SLOPES AND OTHER BREAKS IN GRADE. CORRECT IRREGULARITIES AND AREAS WHERE WATER MAY STAND.
- ALL LAWN AREAS TO RECEIVE SOLID SOD SHALL BE LEFT IN A MAXIMUM OF 1* BELOW FINAL FINISH GRADE. CONTRACTOR TO COORDINATE OPERATIONS WITH ON-SITE CONSTRUCTION MANAGER.
- IMPORTED TOPSOIL SHALL BE NATURAL. FRIABLE SOIL FROM THE REGION, KNOWN AS BOTTOM AND SOIL, FREE FROM LUMPS, CLAY, TOXIC SUBSTANCES, ROOTS, DEBRIS, VEGETATION, STONES, CONTAINING NO SALT AND BLACK TO BROWN IN COLOR.
- ALL LAWN AREAS TO BE FINE GRADED. IRRIGATION TRENCHES COMPLETELY SETTLED, AND FINISH GRADE APPROVED BY THE OWNER'S CONSTRUCTION MANAGER OR ARCHITECT PRIOR TO INSTALLATION.
- ALL ROCKS 3/4" DIAMETER AND LARGER, DIRT CLODS, STICKS, CONCRETE SPOILS, ETC. SHALL BE REMOVED PRIOR TO PLACING TOPSOIL AND ANY LAWN INSTALLATION
- CONTRACTOR SHALL PROVIDE (1") ONE INCH OF IMPORTED TOPSOIL ON ALL AREAS TO RECEIVE LAWN.

SOLID SOD NOTES

- FINE GRADE AREAS TO ACHIEVE FINAL CONTOURS INDICATED. LEAVE AREAS TO RECEIVE TOPSOIL 3" BELOW FINAL DESIRED GRADE IN PLANTING AREAS AND 1" BELOW FINAL GRADE IN TURF
- ADJUST CONTOURS TO ACHIEVE POSITIVE DRAINAGE AWAY FROM BUILDINGS. PROVIDE UNIFORM FOUNDING AT TOP AND BOTTOM OF SLOPES AND OTHER REASKS IN GRADE. CORRECT IRREGULARITIES AND AREAS WHERE WATER MAY STAND.
- ALL LAWN AREAS TO RECEIVE SOLID SOD SHALL BE LEFT IN A
- 5. PLANT SOD BY HAND TO COVER INDICATED AREA COMPLETEL'
- ROLL GRASS AREAS TO ACHIEVE A SMOOTH, EVEN SURFACE, FREE FROM UNNATURAL UNDULATIONS.
- WATER SOD THOROUGHLY AS SOD OPERATION PROGRESSES.
- CONTRACTOR SHALL MAINTAIN ALL LAWN AREAS UNTIL FINAL ACCEPTANCE. THIS SHALL INCLUDE, BUT NOT LIMITED TO: MOWING, WATERING, WEEDING, CULTIVATING, CLEANING AND REPLACING DEAD OR BARE AREAS TO KEEP PLANTS IN A VIGOROUS, HEALTHY CONDITION.
- CONTRACTOR SHALL GUARANTEE ESTABLISHMENT OF AN ACCEPTABLE TURF AREA AND SHALL PROVIDE REPLACEMENT FROM LOCAL SUPPLY IF NECESSARY.
- IF INSTALLATION OCCURS BETWEEN SEPTEMBER 1 AND MARCH 1, ALL SOD AREAS TO BE OVER-SEEDED WITH WINTER RYEGRASS, AT A RATE OF (4) POUNDS PER ONE THOUSAND (1000) SQUARE FEET.

LANDSCAPE TABULATIONS

Required 4.833 s.f. (10%)

Provided 7,288 s.f. (25%) decomposed granite area is not calculated in the landscape area provided

Street Trees requirement: 1 tree required for each 50 l.f. of street 10 shrubs for each 50 l.f. of street frontage

Davis Blvd.- 117.98 l.f.

Provided 2 trees 35 shrubs 2 trees 24 shrubs

Parking lot screen- 20" height evergreen hedge provider

Parking lot landscape: 16 parking spaces Requirement: 1 tree per 20 parking spaces

LANDSCAPE NOTES

- CONTRACTOR SHALL VERIFY ALL EXISTING AND PROPOSED SITE ELEMENTS AND NOTIFY ARCHITECT OF ANY DISCREPANCIES. SURVEY DATA OF EXISTING CONDITIONS WAS SUPPLIED BY OTHERS.
- CONTRACTOR SHALL LOCATE ALL EXISTING UNDERGROUND CONTRACTOR SHALL LOCATE ALL EXISTING UNDERGROUND UTILITIES AND NOTIFY ARCHITECT OF ANY CONFLICTS. CONTRACTOR SHALL EXPROISE CAUTION WHEN WORKING IN THE VICINITY OF UNDERGROUND UTILITIES.
- CONTRACTOR IS RESPONSIBLE FOR OBTAINING ALL REQUIRED LANDSCAPE AND IRRIGATION PERMITS.
- 4. CONTRACTOR TO PROVIDE A MINIMUM 2% SLOPE AWAY FROM ALL
- 5. ALL PLANTING BEDS AND LAWN AREAS TO BE SEPARATED BY STEEL EDGING. NO STEEL TO BE INSTALLED ADJACENT TO SIDEWALKS OR
- 6. ALL LANDSCAPE AREAS TO BE 100% IRRIGATED WITH AN UNDERGROUND AUTOMATIC IRRIGATION SYSTEM AND SHALL INCLUDE RAIN AND FREEZE SENSORS.
- . ALL LAWN AREAS TO BE SOLID SOD BERMUDAGRASS, UNLESS

DECOMPOSED GRANITE NOTES

- Provide Decomposed Granite with 'Stabilizer' Binder additive surfacing as indicated on drawings.
- 2. Submit representative samples of items specified for approval by Landscape Architect, Architect and Owner.
- Decomposed Granite base material shall consist of a natural material mix of granite aggregate not to exceed 1/8" diameter in size and various stages of decomposed earth base.
- 4. Filter Fabric: Fabric shall be 'Mirascape', non-woven needle punched fabric made from polypropylene, non-biodegradable, inert to soil chemicals, acids and alkalines over a pH range of 3 - 12, as manufactured by MIRAFI Inc., or approved equal.
- 5. 'Stabilizer' Binder additive to be provided by:
- Stabilizer Solutions
 1 (800) 336-2468; www.stabilizersolutions.com
 Blend to be 12 16 lbs. of Stabilizer per ton of Decomposed Granite,
- Provide grade stakes at 10 foot centers to insure grade points indicated on drawings are met. Insure scope of subgrade and finish surface meets cross sections indicated in details.
- Prepare subgrade by excavating existing material soils to a maximum depth of 4"
- After excavation, rototill or scarify top 1 inch of subgrade and compact to 95% standard proctor using double drum, single drum or automatic hand tampers.
- 9. Install filter fabric in bottom of excavation to limits of path.
- 10. Place four (4) inches of Decomposed Granite with 'Stabilizer' Binder over a dry sub-base. Do not install on wet sub-base. Provide compaction of materia to maximum limits with automatic hand tampers in one inch lifts, unless noted otherwise on details. Compact to achieve a tight material matrix.
- 11. Refer to Specifications, 02519 for additional notes.
- Provide twenty (20) 50 lbs. bags of pre-mixed Decomposed Granite for future use in repair and maintenance.
- The Contractor shall construct a sample panel 15'-0" x 15'-0" on site, at no expense to the Owner, for approval by the Landscape Architect / Owner prior to commencing work.
- The Contractor shall make any modifications required by the Landscape Architect at no expense to the Owner.

PLANT MATERIAL SCHEDULE

REES					
QTY.	TYPE	COMMON NAME	BOTANICAL NAME	SIZE	REMARKS
2	CE	Cedar Elm	Ulmus crassifolia	3" cal.	container, 13' ht., 5' spread min., 5' clear trunk
7	EP	East Palatka Holly	llex x attenuata 'East Palatka'	30 gal.	container, 6' ht., tree form, single straight trunk
2	LO	Live Oak	Quercus virginiana	3" cal.	container, 13' ht., 5' spread min., 5' clear trunk
SHRUBS					
QTY.	TYPE	COMMON NAME	BOTANICAL NAME	SIZE	REMARKS
100	DWM	Dwarf Wax Myrtle	Myrica pusilla	3 gal.	container 20" ht., 20" spread, 36" o.c.
19	RY	Red Yucca 'Brakelights'	Hesperaloe parviflora 'Brakelight'	3 gal.	container full, well rooted
19	CY	Curve-leaf Yucca	Yucca recurvifolia	3 gal.	container full, well rooted
12	MIS	Adagio Maiden Grass	Miscanthus sinensis 'Adagio'	3 gal.	container, 20" ht., 24" spread
		"			
GROUND	COVERS				
QTY.	TYPE	COMMON NAME	BOTANICAL NAME	SIZE	REMARKS
		'419' Bermudagrass	Cynodon dactylon '419'		Solid Sod refer to notes
		710 Demiddagiass	Cyriodon daciyidii 419		Golid God Teles to Hotes

NOTE: Plant list is an aid to bidders only. Contractor shall verify all quantities on plan. All heights and spreads are minimums. All plant material shall meet or exceed remarks as indicated. All trees to have straight trunks and be matching within varieties.







LANDSCAPE ARCHITECT STUDIO GREEN SPOT. INC 1784 W. McDERMOTT DR SUITE 110
ALLEN, TEXAS 75013
(469) 369-4448
HRIS@STUDIOGREENSPOT.COM

> S BLVD. & PRECINCT LINE ROAD N. RICHLAND HILLS, TEXAS, 76182 DAVIS I CITY OF

COFFEE

တ် BRO

DUTCH


ISSUE: FOR APPROVAL 02.03.2021

DATE:

03.15.2021 SHEET NAME: LANDSCAPE PLAN

SHEET NUMBER:

CASE SUP 2020-09

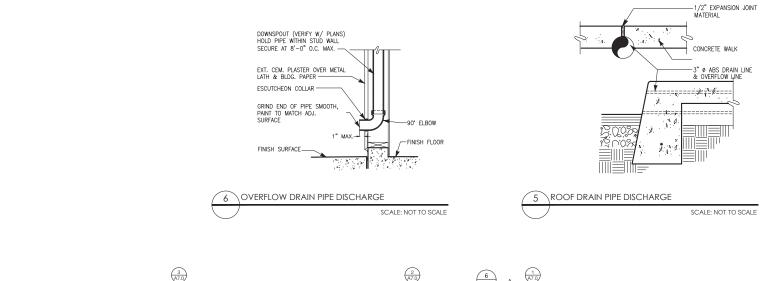



ID TAG	MATERIAL	MANUFACTURER	MODEL	REMARKS
ZONE 1 (BC	DDY)			
1A	EXTERIOR CEMENT PLASTER	SHERWIN WILLIAMS	GP-0642 DB BLUE	DB BLUE; MEDIUM SAND/CEMENT PLASTER
1B	EXTERIOR CEMENT PLASTER	SHERWIN WILLIAMS	GP-0624 DB GRAY	DB GRAY; MEDIUM SAND/CEMENT PLASTER
ZONE 2 (TC	OWER) (Z2)			
2	FIBER CEMENT SIDING	NICHIHA	VINTAGE WOOD - AWP-1818 - ASH	ORIENTATION: HORIZONTAL;
ZONE 3 (3'-:	2" BASE)			
	STONE VENEER	ELDORADO STONE	STACKED STONE, SILVER LINING	
3	STONE VENEER SILL	ELDORADO STONE	SNAPPED EDGE WAINSCOT SILL; PEWTER	
ZONE 4 (FR	RAMED CANOPY)			
4	FASCIA		METAL FASCIA	COLOR TO MATCH DB DARK GRAY
5	SOFFIT	HEWN ELEMENTS	NATURAL NORTHWESTERN SPRUCE	1X6, T&G, ½" REVEAL
6	COLUMNS	ELDORADO STONE	STACKED STONE, SILVER LINING	







ARMÉT DAVIS NEWLOVE & ASSOCIATES, AIA ARCHITECTS

1330 OLYMPIC BLVD. SANTA MONICA, CALIFORNIA 90404 PH 310 452-5533 FAX 310 450-4742

THE USE OF THESE PLANS AND SPECIFICATIONS SHALL BE RESTRICTED TO THE ORGANIA. SITE FOR WHICH THEY WERE PREPARED AND PULLCHOINTO THESEOF IS DEPRESSEY MAINTED TO SUCH USE, RE-LOS, REPROJUCTION OF PUBLICATION OF TO SUCH USE, RE-LOS, REPROJUCTION OF PUBLICATION OF THE PLANS AND SPECIFICATIONS ENABLS CONTINUE HAS ADDITION. ON SPECIFICATION SERVING CONTINUE PRIVATE ADDITIONS SHALL CONTINUE PRIVATE PRIVATE ADDITIONS SHALL CONTINUE PRIVATE PRIV





O: TX0503
se - New Freestanding Store
re

Project No: TXO Dutch Bros Coffee - New F 2040 - A1 PROTOTYPE SWC DAVIS BLVD & PRECINCT NORTH RICHLAND HILLS, TX

DATE: 03/11/21

REV: DATE: DESCRIPTION:

01/08/21 SUP RESUBMITTAL

03/15/21 SUP RESUBMITTAL

SHEET NAME:

BUILDING ELEVATIONS

SHEET NUMBER:


CASE SUP 2020-09

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Note
1. THE EXTERIOR LIGHTING DEPICTED ON THE SITE PLAN MUST COMPLY WITH THE REQUIREMENTS OF SECTION 118-728 OF THE NORTH RICHLAND HILLS ZONING ORDINANCE. 2. AS A CONDITION OF APPROVAL, THE DRC WILL RECOMMEND THE COLOR OF THE FIXTURES AND POLES BE LIGHT GRAY FINISH TO MAINTAIN A CONCISTENT APPEARANCE AND DESIGN WITH PROPERTIES TO THE SOUTH ALONG THIS SECTION OF DAVIS BOULEVARD. 3. THE COLOR OF ALL PARKING LOT LIGHTING POLES AND FIXTURES MUST BE LIGHT GRAY IN COLOR.





0 0 0 Plan View

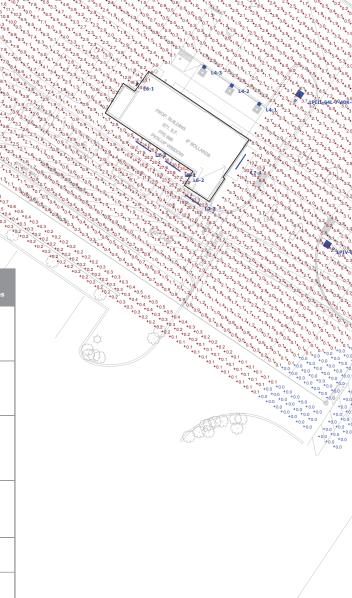0.3 fc | 1.8 fc | 0.0 fc | N/A 4.1 fc 38.3 fc 0.0 fc N/A N/A

PROP. TXDOT TYPE-7
RAMP. REFER TXDOT
DETAIL PED-18 FOR
DETAILS

GC TO RETROFIT THE EX.
ENTRY ISLAND W/ A
CONTRASTING COLOR INTE
TO HIGHLIGHT THE
RIGHT-INRIGHT-OUR DRIVE

-64L-7-40K--HSS NV-1-T4-64L-7-40K-UNV-HSS T4 OPTICS WITH BLACK HOUSE SHIELD NLS Lighting NV-1-T4-64L-7 40K-HSS.IES 8978 0.95 136 1PIV-64L-7--40K-HSS CAST FINNED METAL HOUSING,
MACHINED METAL HEAT SINK, 1
CIRCUIT BOARD WITH 1 LED,
MOLDED PLASTIC REFLECTOR
WITH SEMI-SPECULAR FINISH,
CLEAR FLAT GLASS LENS IN
CAST BROWN PAINTED METAL
FRAME.

ONE WHITE MULTIMULTIDIODE (LED), TILTED
DIODE (LED) RAB LIGHTING WPLED26-WPLED26/D10 (WALLPACK) - ALED26-ALED26/D10 (AREA LIGHTER) 1 rab02619.ies 0.95 L6 3 GENERATION BRANDS LLC LED WALL SCONCE 102171228CHI-079B 0.95 Generation Brands 7000WVEX930 4XUNV WALL-.ies L4 CROWN-L144-277V 840_BA110 LED CROWN-L144-277V-840_BA110_IES NA2002.ies 0.95 L7 NV-1-T4-128L-1-40K- T4 OPTICS WITH BLACK HSS UNV-HSS NV-2-T4-128L-1-40K-HSS.IES 1636 NLS Lighting 24955 0.95 100% 4PIV-128L-

NV-1-T3-64L-7-40K-HSS.IES

9116

0.95

NV-1-T3-64L-7-40K-UNV-HSS

1PIII-

1-40K-

-HSS

NV SERIES WITH T3 OPTICS, BLACK HOUSE SIDE SHIELD

Designer


1/21/2021 Scale

Not to Scale Drawing No.


FACTORY DRAWING


SCOPE OF WORK: MANUFACTURE & INSTALL (3) SETS OF ILLUMINATED CHANNEL LETTERS WITH REMOTE RACEWAYS



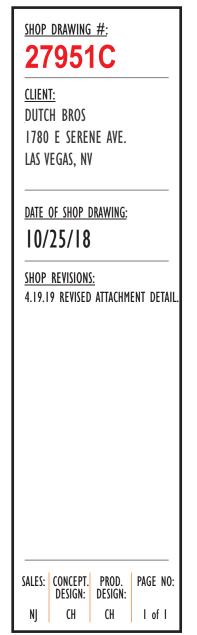




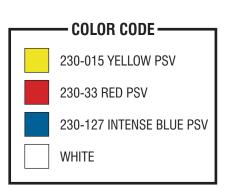

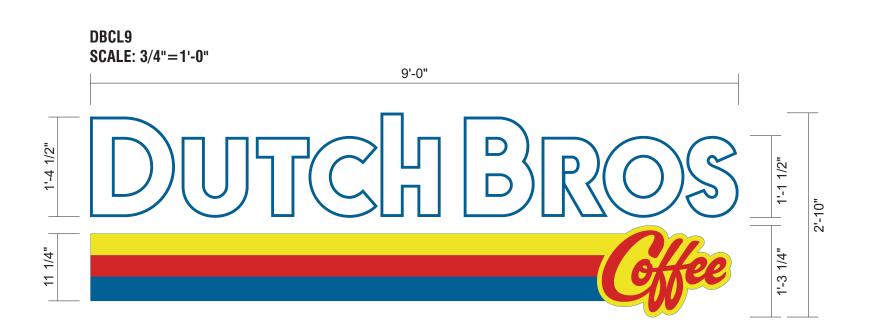

FABRICATED REMOTE RACEWAY

.040 PRE-COAT WHITE ALUMINUM

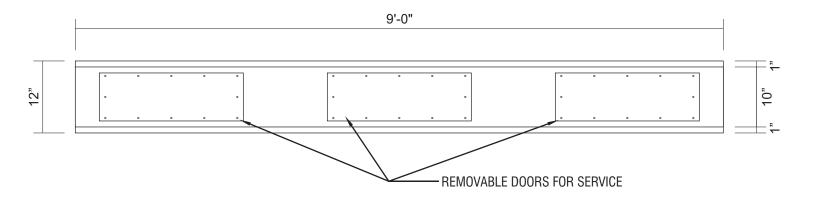


INTERNALLY ILLUMINATED FACE-LIT FLUSH MOUNTED CHANNEL LETTERS 5" DEEP CHANNEL LETTERS.
RETURNS & TRIM CAP TO MATCH PANTONE 7691 C "INTENSE BLUE".
WHITE ACRYLIC FACES.
230-127 INTENSE BLUE PSV, 230-015 YELLOW PSV, 230-33 RED PSV.
LED ILLUMINATION.
FLUSH MOUNTED WITH REMOTE RACEWAY BEHIND PARAPET WALL.

ATTACHMENT DETAIL SCALE: 3/4"=1'-0"

SIDE VIEW

5"

CHANNEL LETTERS WITH REMOTE RACEWAY

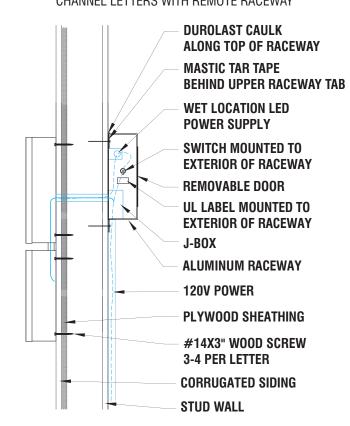

FACTORY DRAWING

SCOPE OF WORK: MANUFACTURE & INSTALL (3) ILLUMINATED WINDMILL LOGOS






ES&A SIGN & AWNING
89975 PRAIRIE RD. | EUGENE, OR 97402
P 541.485.5546 | F 541.485.5813

 CH


SALES: CONCEPT. PROD. PAGE NO: DESIGN: DESIGN:

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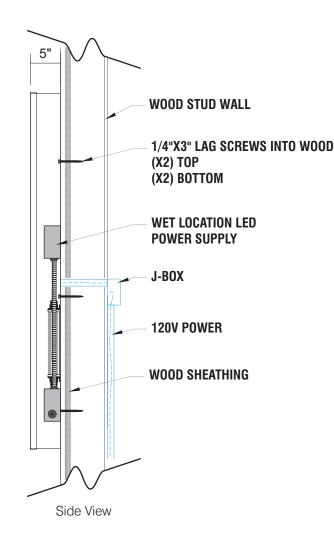
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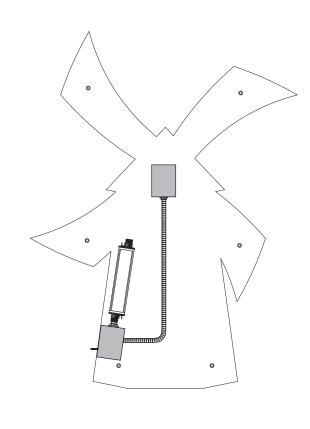
DBW13 SCALE: 3/4"=1'-0"

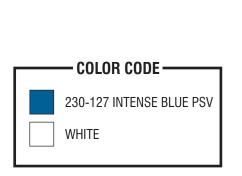

ATTACHMENT DETAIL SELF CONTAINED CHANNEL LOGO

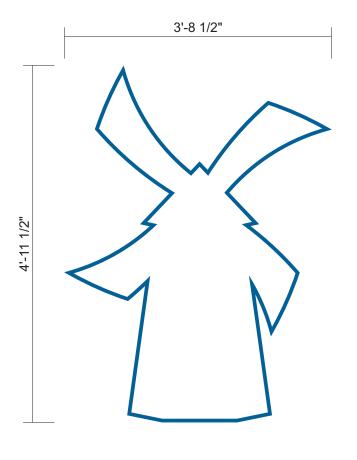


ATTACHMENT DETAIL SELF CONTAINED CHANNEL LOGO



INTERNALLY ILLUMINATED FACE-LIT FLUSH MOUNTED CHANNEL WRAP LOGO 5" DEEP CHANNEL WRAP.
RETURNS & TRIM CAP PAINTED TO MATCH PANTONE 7691 C "INTENSE BLUE".
WHITE ACRYLIC FACE.
230-127 INTENSE BLUE PSV OUTLINE.
LED ILLUMINATION.

FLUSH MOUNTED SELF CONTAINED INSTALLATION.

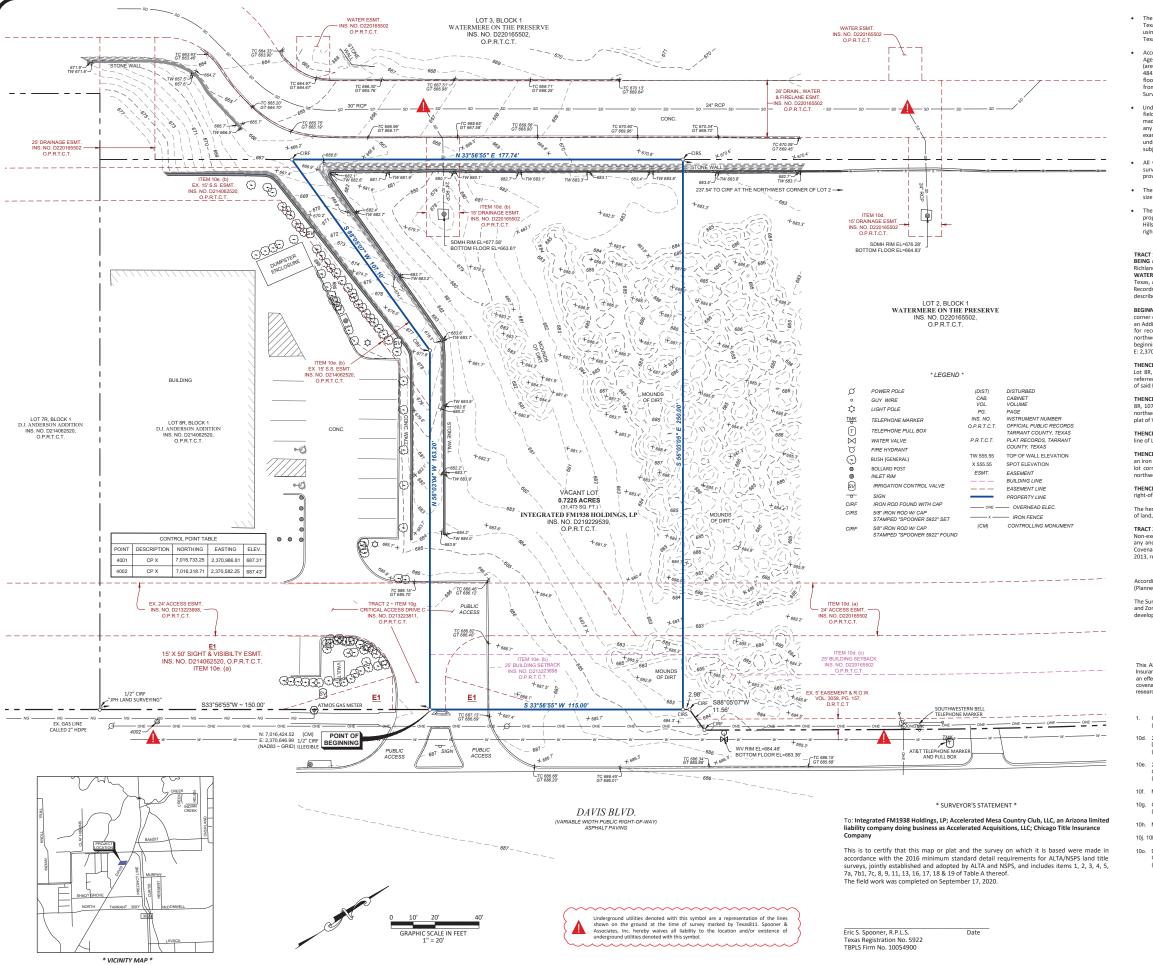

- According to the Flood Insurance Rate Man published by the Federal Emergency Man According to the intollinsulative kate wap published by the receival timegenety wanagement. Agencylin Department of Homeland Security, the subject property appears to be located in Zone "X" (areas determined to be outside the 0.2 % annual chance floodplain) as shown on Map No. 4848900090K; map revised September 25, 2009, for Tarrant County and incorporated areas. This flood statement does not imply that the property and/or structures located in Zone "X" will be free from flooding or flood damage. This flood statement shall not create liability on the part of the
- Underground utilities shown hereon were taken from record information, actual locations were not field verified except at surface structures such as manholes, fire hydrantis, etc. No attempt has been made as a part of this Survey to confirm, obtain or show data concerning the depth or condition of any utility or municipal/public service facility. Subsurface and environmental conditions were not examined or considered as a part of this Survey. No statement is made concerning the existence of underground or overhead containers or facilities, which may affect the use or development of the

- The Surveyor has no knowledge of any changes in street right-of-way lines either completed or proposed. Surveyor hereby advises all interested parties to consult with the City of North Richland rning this subject prior to planning, designing or constructing improvements near any

* LEGAL DESCRIPTIONS *

TRACT 1:

BEING a 0.7225 acre tract of land located in the Thomas Peck Survey, Abstract No. 1210, City of North Richand Hills, Tarrant County, Texas, said 0.7225 acre tract of land being a portion of LOT 2, BLOCK 1, WATERMERE ON THE PRESERVE, being an Addition to the City of North Richland Hills, Tarrant County, Texas, according to the plat thereof filed for record in Instrument Number D220165502, Official Public Records, Tarrant County, Texas (0.P.R.T.C.T.), said 0.7225 acre tract of land being more particularly described by metes and bounds as follows:

BEGINNING at a 1/2 inch iron rod with an illegible cap found (Controlling Monument) at the south lot corner of the said Lot 2, same being the east lot corner of Lot 8R, Block 1, D.J. Anderson Addition, being an Addition to the City of North Richland Hills, Tarrant County, Texas, according to the plat thereof filed for record in Instrument Number D214062520, O.P.R.T.C.T., said beginning point also being on the northwest right-of-way line of Davis Boulevard (being a variable width public right-of-way), said beginning point having a NAD83 Texas North Central Zone (4202) grid coordinate of N: 7,016,424.52 and F: 2.370.646, 2000.

THENCE North 56"03"04" West, along the south lot line of said Lot 2 and along the north lot line of said Lot 88, 163.20 feet to a 5/8 inch iron rod with a cap stamped "SPOONER S922" found (hereinafter referred to as capped iron rod found) at a south lot corner of said Lot 2, same being a north to corner of said Lot 8R;

THENCE South 88°05'07" West, along a south lot line of said Lot 2 and along a north lot line of said Lot 8R, 107.10 feet to a capped iron rod found at the southwest lot corner of said Lot 2, same being the northwest lot corner of said Lot 8R, said point also being on a southeast lot line of Lot 3, Block 1 of said plat of Watermere on the Preserve;

THENCE North 33°56'55" East, along the northwest lot line of said Lot 2 and along the said southeast lot line of Lot 3, 177.74 feet to a 5/8 inch iron rod with a cap stamped "SPOONER 5922" set;

THENCE South 56'03'05" East, departing the said lot lines and over and across said Lot 2, 250.00 feet to an iron rod set on the southeast lot line of said Lot 2, from which a capped iron rod found at a southeast lot corner of said Lot 2 bears North 33'55'55" East 2.98 feet, said iron rod set being on the said northwest right-of-way line of Davis Boulevard;

THENCE South 33"56'55" West, along the southeast lot line of said Lot 2 and along the said northwest right-of-way line, 115.00 feet to the POINT OF BEGINNING.

The hereinabove described tract of land contains a computed area of 0.7225 acres (31.473 square feet)

ording to the City of North Richland Hills Zoning Map, the subject property is currently zoned "PD"

The Surveyor hereby advises all interested parties to contact the City of North Richland Hills Planning and Zoning Department to verify all Zoning Restrictions and Regulations prior to the planning, designing, developing or constructing on the subject property.

* TITLE COMMITMENT NOTES *

This ALTAINSPS Land Title Survey was prepared with the benefit of a copy of the commitment for Title Insurance prepared by Chicago Title Insurance Company, Commitment and G.F. No. 4712018600 having an effective date of September 13, 2020 and issued October 81, 2020; and only reflects those easements, covenants, restrictions, and other matters of record listed in Schedule B of said Commitment. No othe research for matters of record, not listed in said Commitment, was preformed by Spooner & Associates, Inc.

- Covenants, Conditions, Restrictions and Easements recorded in Ins. No. D213223811, O.P.R.T.C.T.
- 10d. 24' Access Easement, 15' Drainage Easement, 25' Building Setback recorded in Ins. No. D220165502, D.P.R.T.C.T. (Affect Tract 1, Shown)
- 25' Building Setback Line and 15' x 50' Sight/Visibility Easement recorded in Ins. No. D214062520, O.P.R.T.C.T. (Affects Tracts 1 & 2, shown)
- 10f Mineral Interests (Non-Survey Item)
- 10g. Covenants, Conditions, Restrictions and Easements recorded in Ins. No. D213223811, O.P.R.T.C.T. (Affects Tracts 1 & 2, shown as applicable)
- 10j. 10k. 10l. 10m. Mineral Interests (Non-Survey Items)
- 10o. Detention/Retention Storage Facility Maintenance Agreement recorded in Ins. No. D220180218, (Does not affect project area, subject property is not subject to obligations set forth in said document)

POONER &
SSOCIATES

RESIDENCES SERVICE
THE STATEMENT SERVICE
THE STATEMENT SERVICES
THE STA SA

> ACRE (31,473 SQ. FT.) TRACT OF LAND BLOCK 1, WATERMERE AT THE PRESERVE, CHLAND HILLS, TARRANT COUNTY, TEXAS 3 A 0.7225 *t* 3 IN LOT 2, E NORTH RIC BEING CATED I TY OF N

SURVEY

A/NSPS

FOR

PREPARED

INTEGRATED TJ

DATE: 11/16/2020

S&A JOB NO. 18026.2

CALE: 1" = 20'

DRAWN BY: R OSMENT CHECKED BY: F. SPOONER

REVISIONS

11/16/20 changed lot configura

SHEET OF 1