




MASONRY GROUP A	BRICK	87%
ACCENT	METAL	13%

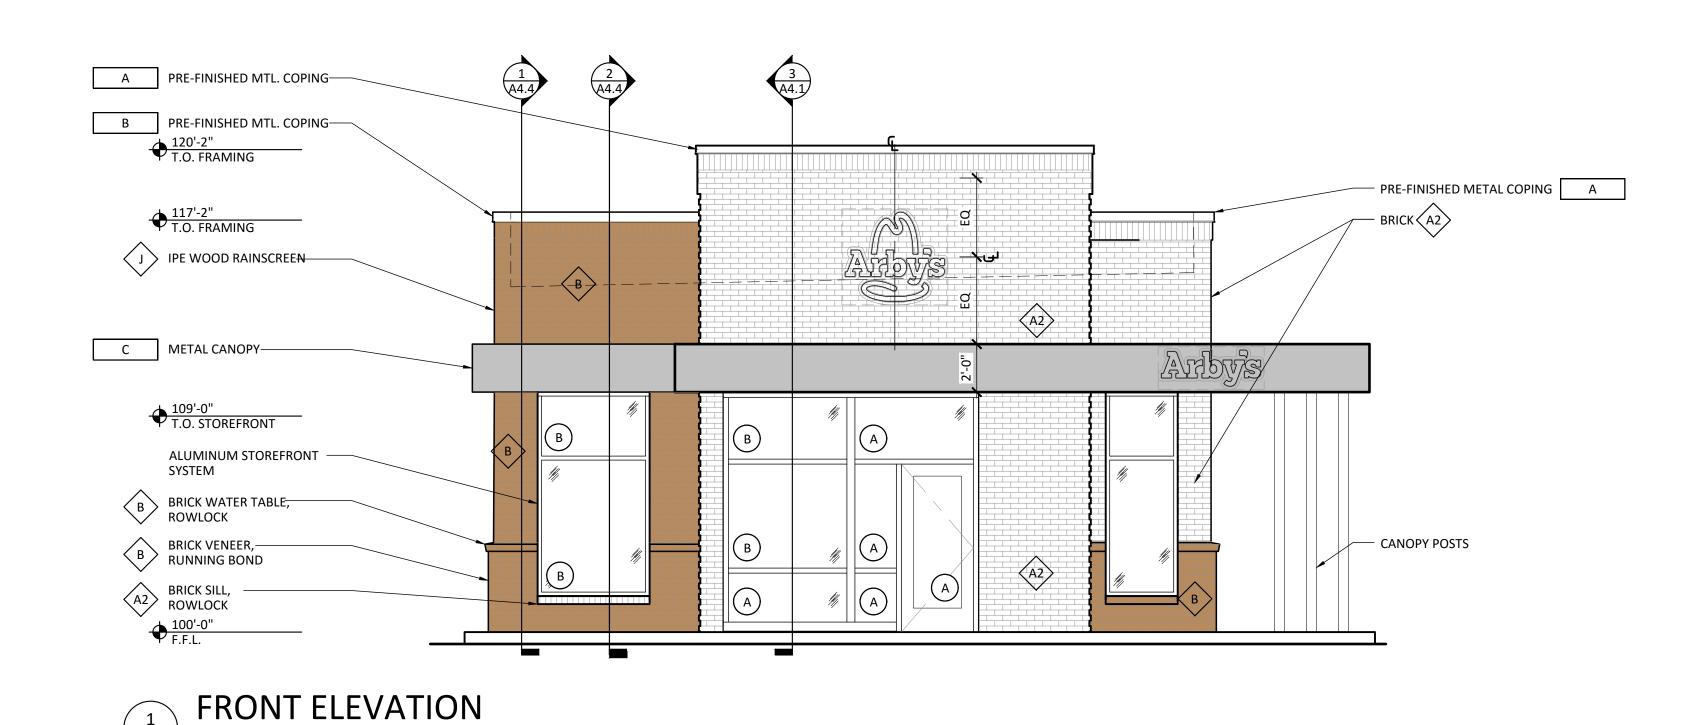

MAS	ONRY GROUP A	BRICK	90%
	ACCENT	METAL	10%

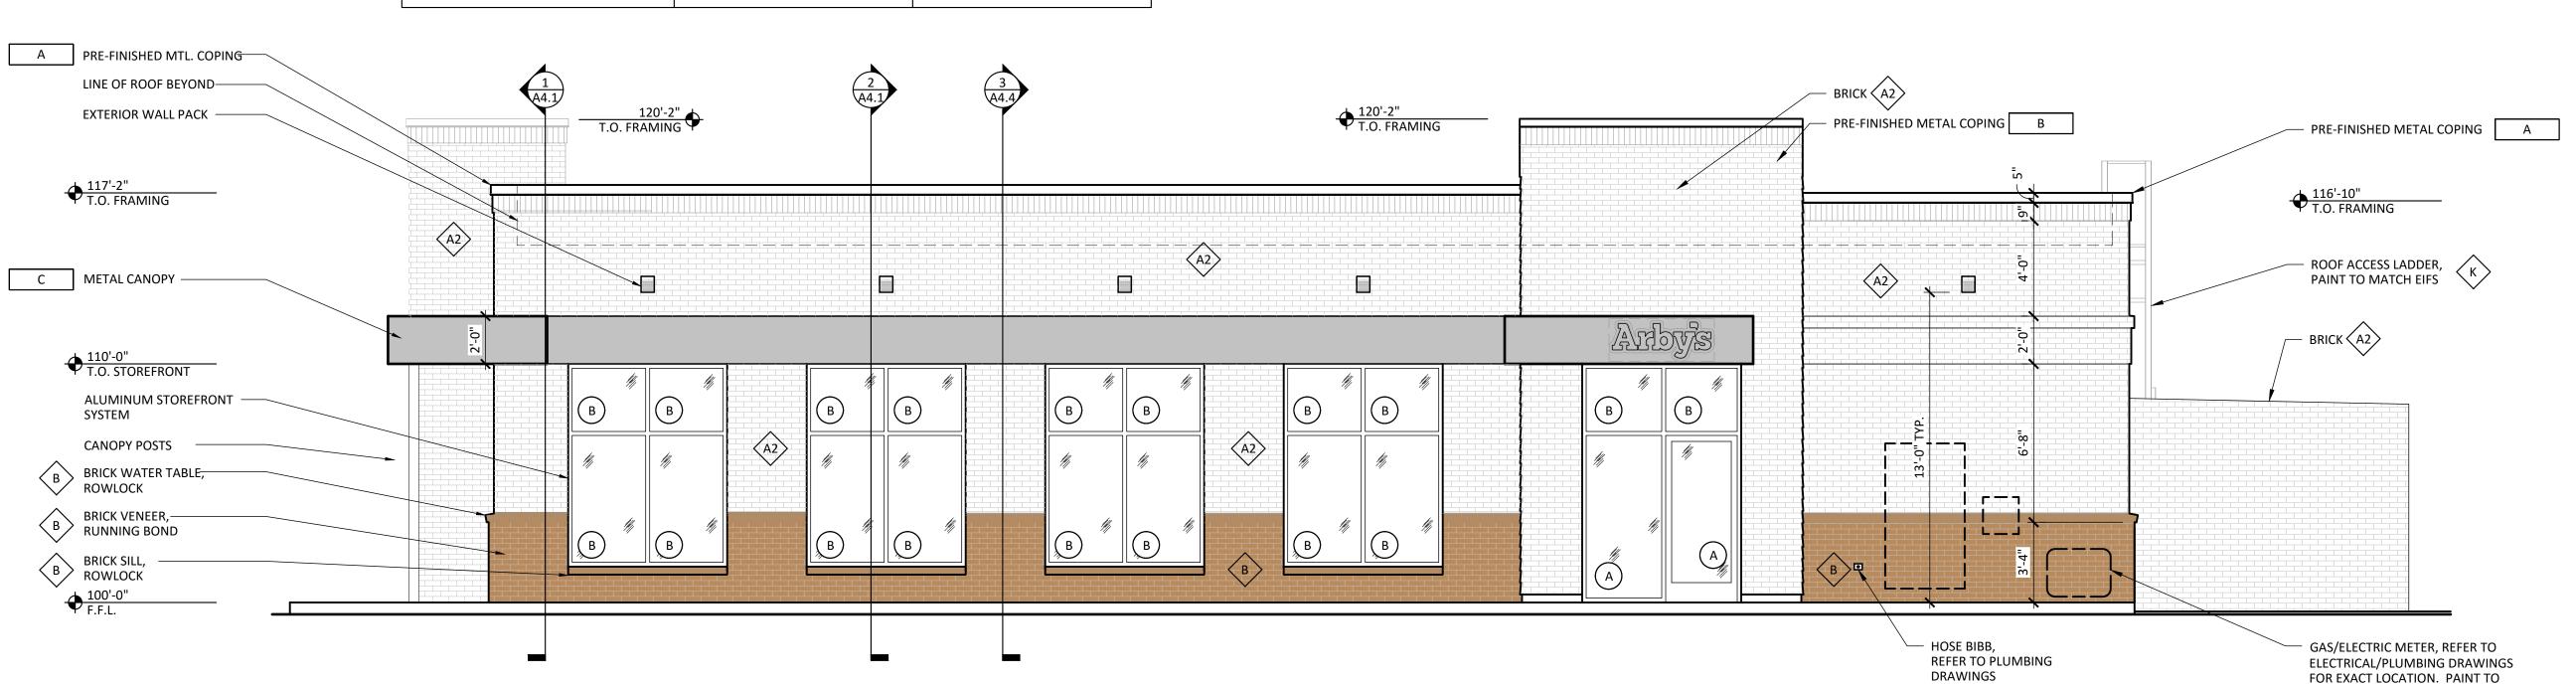




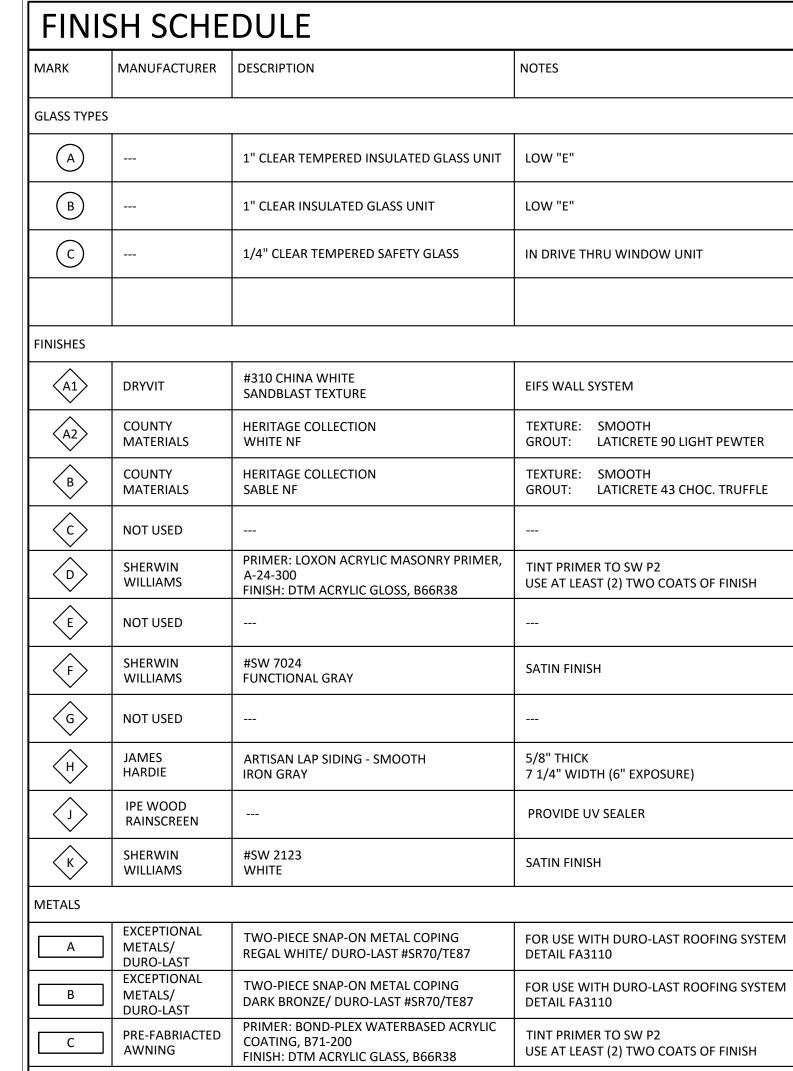

- PAINT ALL EXPOSED METERS, SERVICE ENTRANCES, GAS PIPE, ROOF ACCESS LADDER, ETC. TO MATCH ADJACENT EXTERIOR WALL SURFACE.
- 2. PROVIDE TEMPORARY MASKING OF EXPOSED STAINLESS STEEL DURING ACID WASHING OF MASONRY.
- 3. PROVIDE SOLID MASONRY UNITS AT THE ENDS OF JAMBS , SILLS, ETC.
- 4. TO HELP PREVENT EFFLORESCENCE ALL MASONRY UNITS ARE TO BE MANUFACTURED WITH INTEGRAL WATER REPELLANT. WATER REPELLENT ADMIXTURE IS TO BE MIXED IN AND PRE-WASHED SAND IS TO BE USED IN ALL MORTAR MIXES.


MATCH BRICK


. MAKE SURE THAT WALL WEEPS AND FLASHING ARE INSTALLED CORRECTLY. DO NOT BLOCK WEEPS. REFER TO SPECIFICATIONS ON SHEET SP-2.

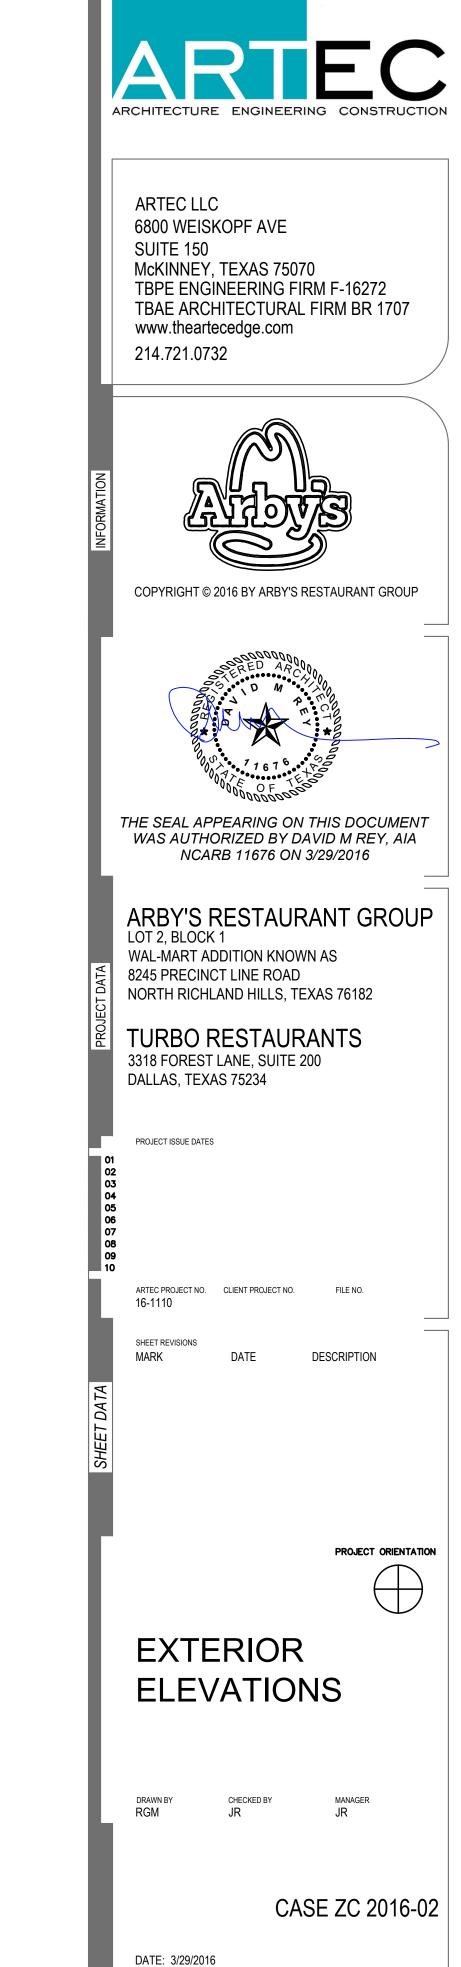


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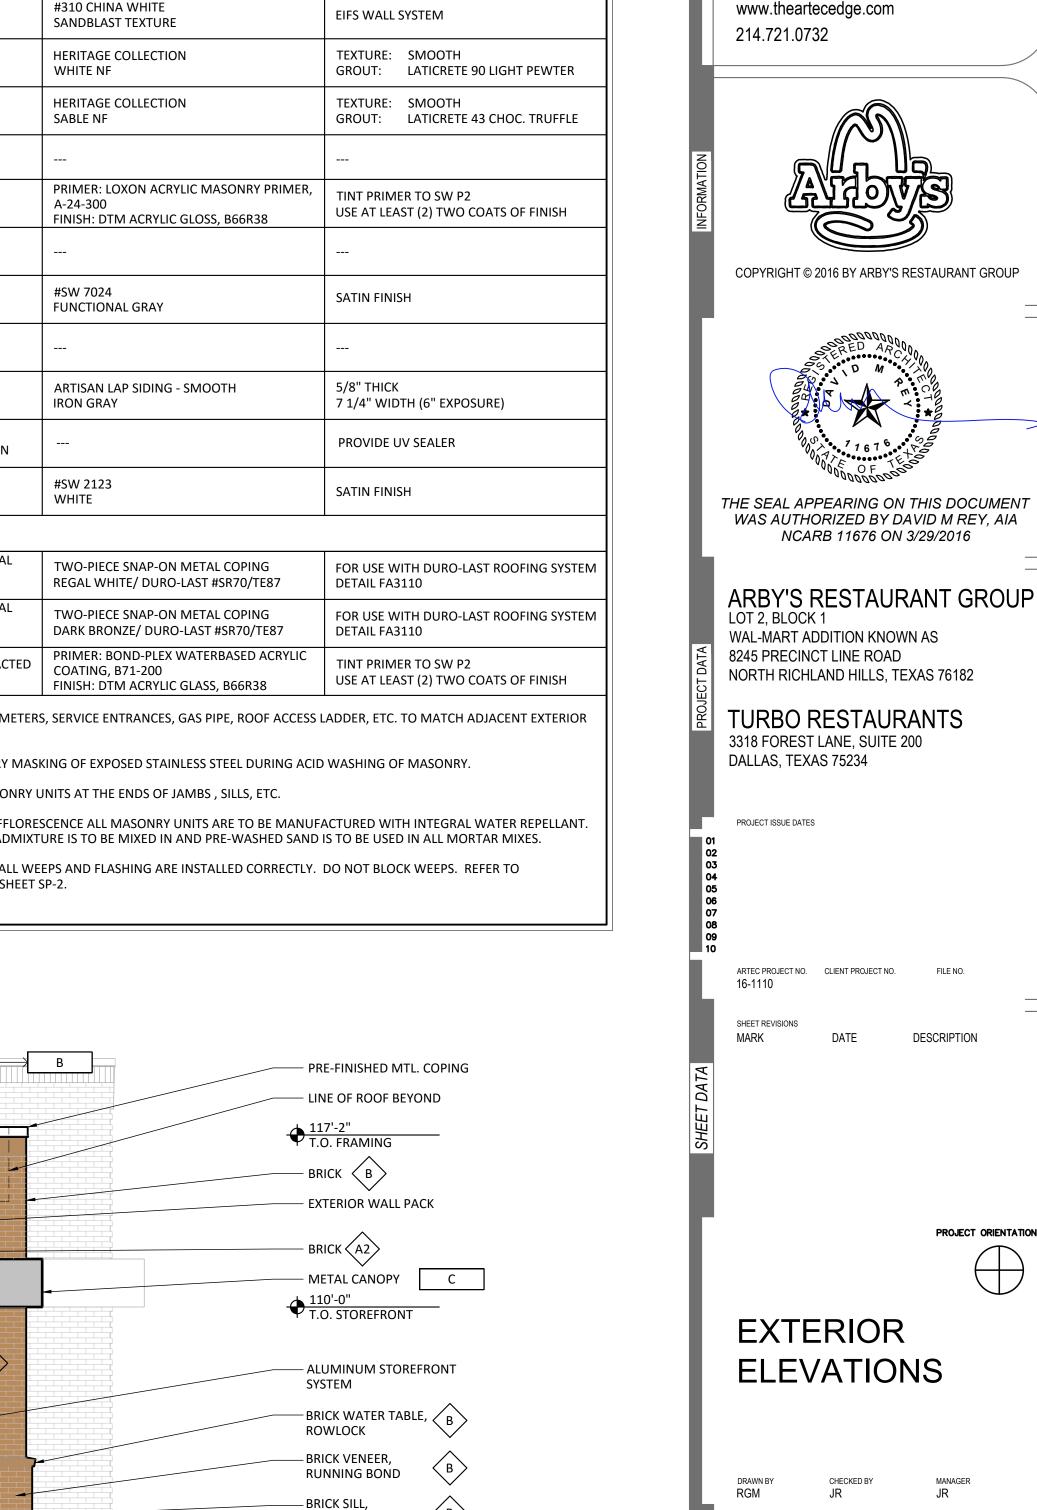
MASONRY GROUP A **BRICK** 100%



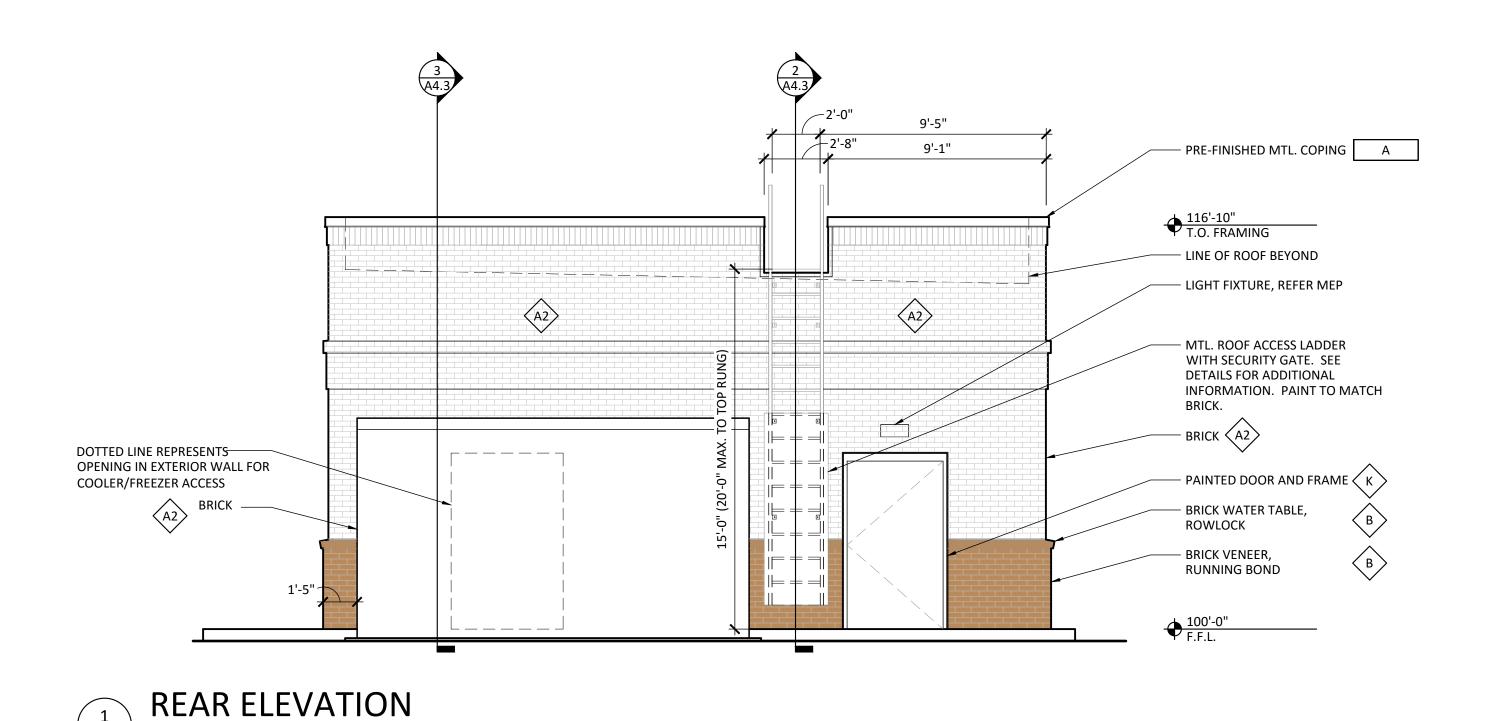

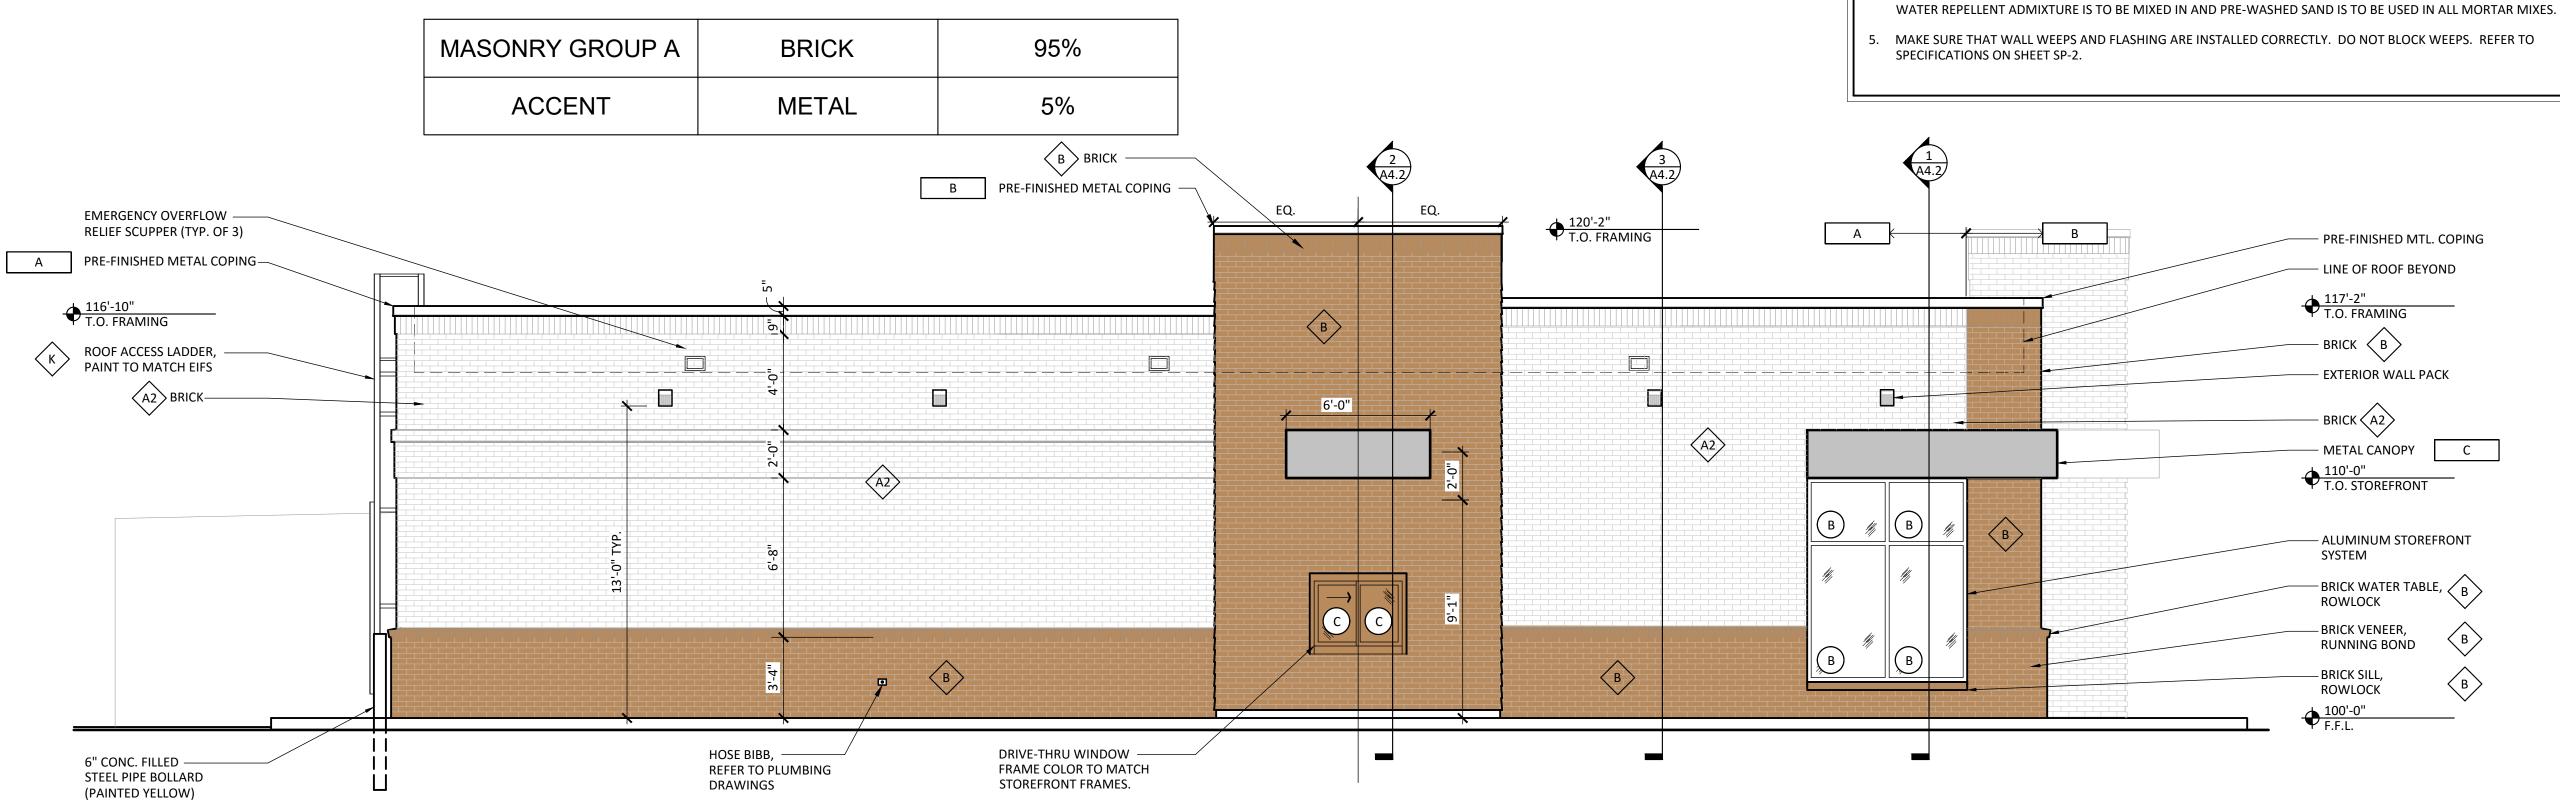

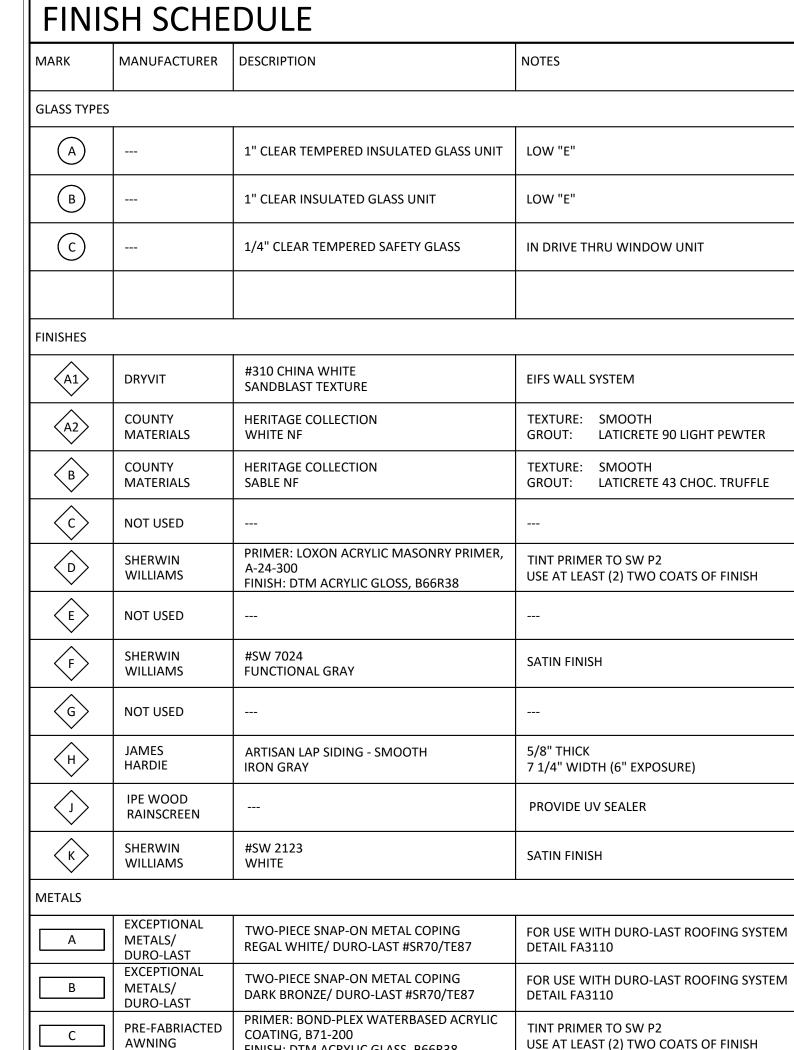- 1. PAINT ALL EXPOSED METERS, SERVICE ENTRANCES, GAS PIPE, ROOF ACCESS LADDER, ETC. TO MATCH ADJACENT EXTERIOR
- 2. PROVIDE TEMPORARY MASKING OF EXPOSED STAINLESS STEEL DURING ACID WASHING OF MASONRY.
- 3. PROVIDE SOLID MASONRY UNITS AT THE ENDS OF JAMBS, SILLS, ETC.
- 4. TO HELP PREVENT EFFLORESCENCE ALL MASONRY UNITS ARE TO BE MANUFACTURED WITH INTEGRAL WATER REPELLANT.
- MAKE SURE THAT WALL WEEPS AND FLASHING ARE INSTALLED CORRECTLY. DO NOT BLOCK WEEPS. REFER TO



ARTEC

ARTEC LLC

SUITE 150

6800 WEISKOPF AVE

McKINNEY, TEXAS 75070

TBPE ENGINEERING FIRM F-16272

TBAE ARCHITECTURAL FIRM BR 1707


DESCRIPTION

PROJECT ORIENTATION

CASE ZC 2016-02

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DATE: 3/29/2016

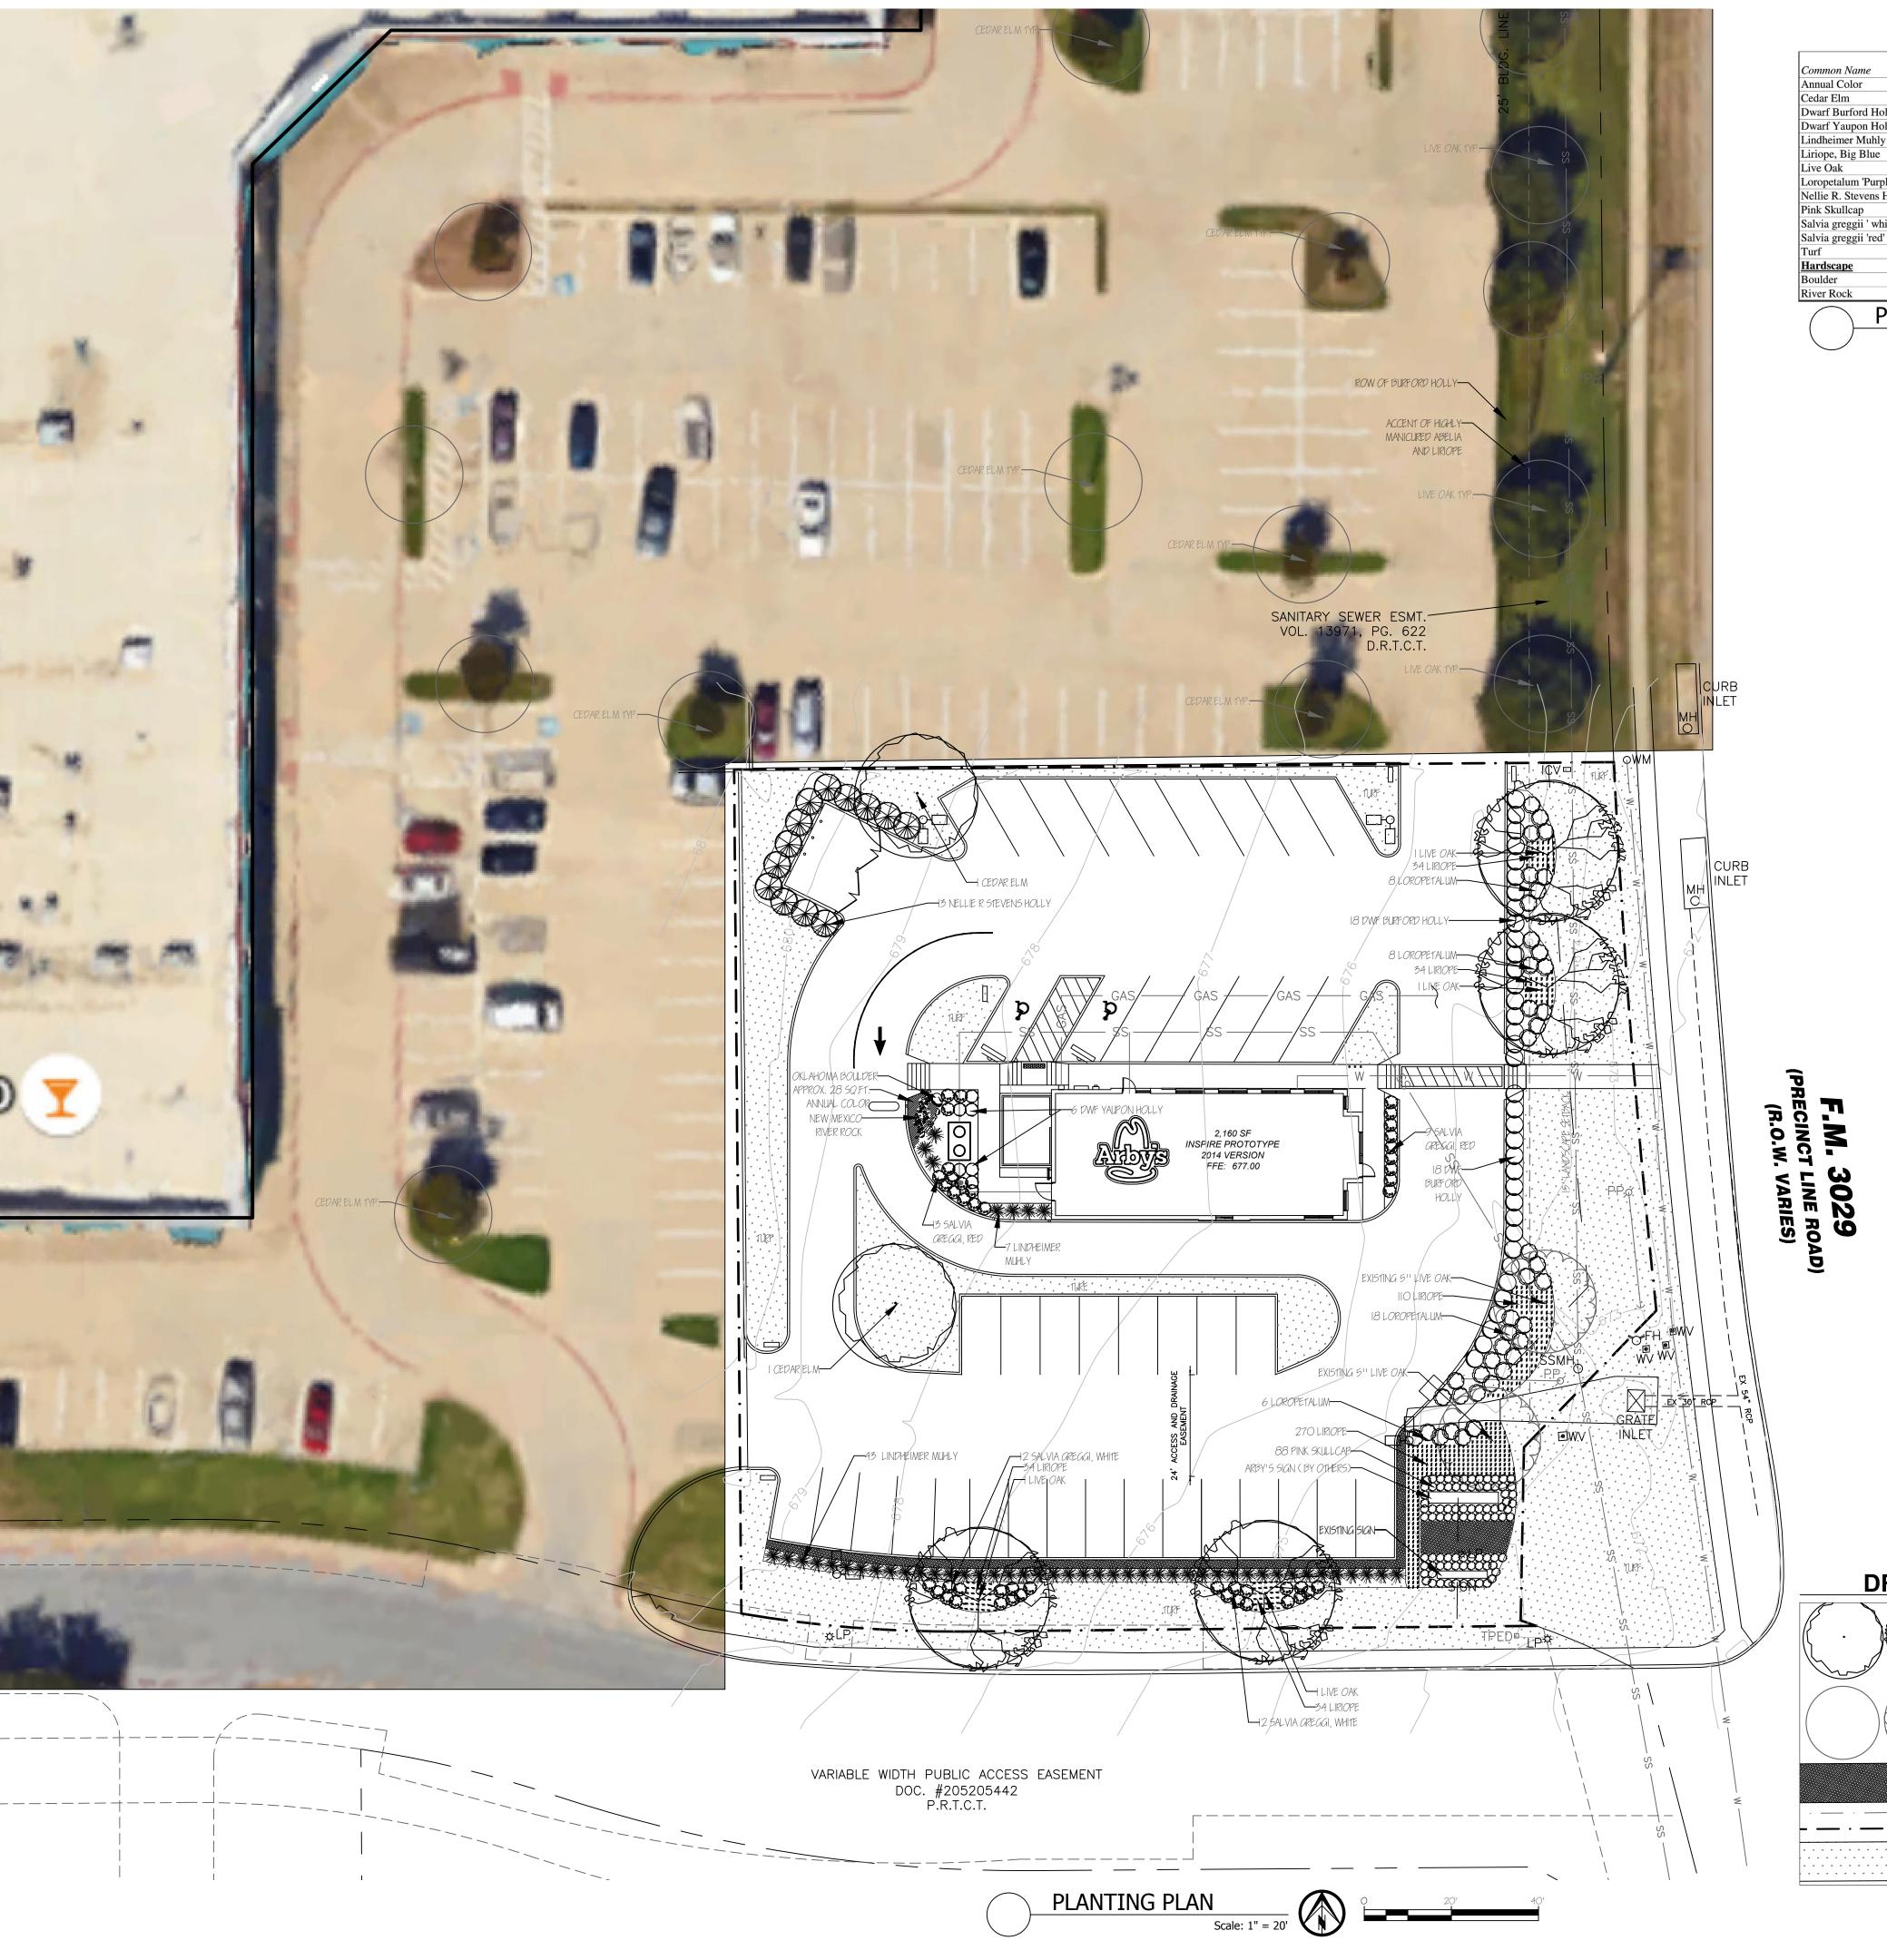

			Texas			
Common Name	Botanical Name		Native	Size	Qty	Notes
Annual Color	varies per season	Annual		28 sq ft		
Cedar Elm	Ulmus crassifolia	Tree	Yes	65 gal	2	3" caliper min.
Dwarf Burford Holly	Ilex cornuta 'Burfordii nana'	Shrub	No	5 gal	36	30" tall, 3' o.c.
Dwarf Yaupon Holly	Ilex vomitoria 'Nana'	Shrub	Yes	3 gal	6	
Lindheimer Muhly / Big Muhly	Muhlenbergia lindheimeri	Grass	Yes	3 gal	50	
Liriope, Big Blue	Liriope muscari 'Big Blue'	Groundcove	No	4" pots	515	
Live Oak	Quercus virginiana	Tree	Yes	65 gal	4	3" caliper min.
Loropetalum 'Purple Pixie'	Loropetalum chinensis 'Purple Pixie'	Shrub	No	5 gal	40	30" tall, 3' o.c.
Nellie R. Stevens Holly	Ilex x attenuata 'Nellie R. Stevens'	Shrub	No	7 gal	13	3' tall at planting
Pink Skullcap	Scutellaria suffrutescens	Perennial	Mexico	1 gal	88	
Salvia greggii ' white'	Salvia greggii	Perennial	Yes	3 gal	24	
Salvia greggii 'red'	Salvia greggii	Perennial	Yes	3 gal	22	
rf Bermuda grass sod				12,684 8	sq.ft.	
<u>Hardscape</u>						
Boulder	Moss Boulders			0.2 ton		
River Rock	New Mexico 2" -3"	3" depth		26 sq. ft	:	

PLANT LIST

# **Jurisdiction of Project**

REGULATORY AUTHORITIES:

CITY OF NORTH RICHLAND HILLS 7301 NE LOOP 820 NORTH RICHLAND HILLS, TX 76180 817-427-6000

TEXAS DEPARTMENT OF LICENSING AND REGULATION ELIMINATION OF ARCHITECTURAL BARRIERS

E.O. THOMPSON STATE OFFICE BUILDING 920 COLORADO

AUSTIN, TEXAS 78701 (512) 463-3211

(512) 475-2886 (FAX)

## **Landscaping Requirements**

NORTH RICHLAND HILLS CODE OF ORDINANCES CHAPTER 114 VEGETATION

PROVIDED: 12,618 SF (31 %)

LANDSCAPE AREA PERCENTAGE A. NOT LESS THAN 15% OF LOT AREA LANDSCAPE (LOT: 39,291 SF) REQUIRED: 5,894 SF

LANDSCAPE SETBACK
A. MINIMUM WIDTH OF 15' ADJACENT TO ALL PUBLIC STREET R.O.W. REQUIRED: 15' WIDTH

PROVIDED: 15' WIDTH B. 1 TREE OR 2 ORNAMENTAL PER 50 LF OF STREET FRONTAGE (210 LIN FT.) REQUIRED: 4 TREES OR 8 ORNAMENTAL TREES OR COMBINATION

PROVIDED: 2 CANOPY TREES + 2 EXISTING CANOPY TREES

C. 10 SHRUBS PER 50 LF OF STREET FRONTAGE (210 LIN. FT) REQUIRED: 42 SHRUBS

PROVIDED: 76 SHRUBS

A. 1 LARGE TREE PER 20 PARKING SPACES (40 SPACES) WITH NO PARKING SPACE LOCATED MORE THAN 100' FROM A LARGE TREE REQUIRED: 2 TREES PROVIDED: 2 TREES

B. ALL SHRUBBERY FLOWERING PLANTS, AND TREES PLANTED IN PARKING LOT ISLANDS OR ADJACENT TO PARKING LOTS SHALL BE SETBACK 2' FROM ANY CURB WHERE VEHICLES MAY FACE.


TREE PRESERVATION 2 EXISTING 5" LIVE OAK TO REMAIN

LANDSCAPE DOES NOT OBSTRUCT TRAFFIC VISIBILITY.


## **Irrigation Requirements**

UNDERGROUND AUTOMATIC SPRINKLING SYSTEM PROVIDED.
SYSTEM DESIGNED AND INSTALLED ACCORDING TO TCEQ LAWS AND
REGULATIONS PROVIDING FOR 100% COVERAGE ON ALL LANDSCAPE AND TURF. THE SYSTEM SHALL INCLUDE A FREEZE-RAIN SENSOR.

# **Site Location**

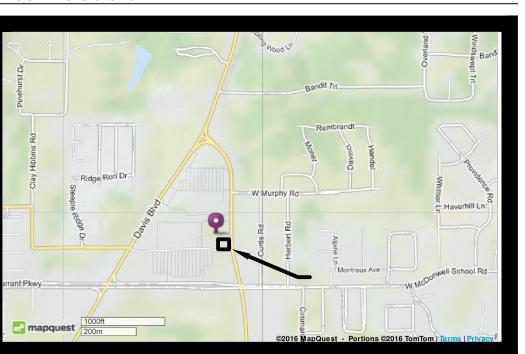


# **DRAWING KEY**

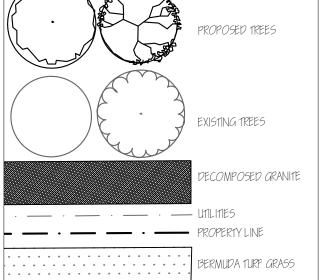

# **Owner & Professionals Information**

OWNER
TURBO RESTAURANTS
3318 FOREST LANE, #200, DALLAS, TX 75234 ENGINEER ARTEC LLC LANDSCAPE ARCHITECT FELDMAN DESIGN STUDIOS 6800 WEISKOPF AVE, SUITE 150, P.O. BOX 832346, McKINNEY, TEXAS 75070 RICHARDSON, TEXAS 75083 ATTN: CAROL FELDMAN, 972-980-1730

> **ZONING CASE ZC 2016-02** LANDSCAPE PLANTING PLAN

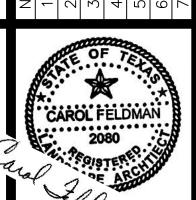


These draw... been prepared counder the supervision of Carol Feldman, Registered Landscape Architect #2080, Licensed Irrigator LI #20245



LANDS


SHEET NO.

L1.01

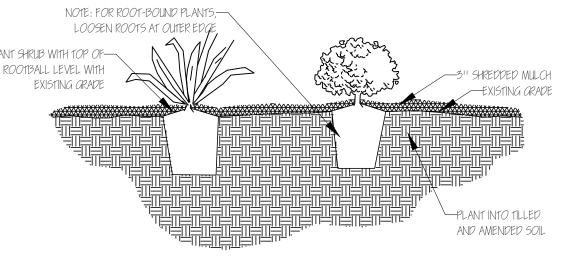

# SHRUB & ORNAMENTAL GRASS PLANTING DETAIL

PERENNIAL PLANTING DETAIL Scale: Not to scale

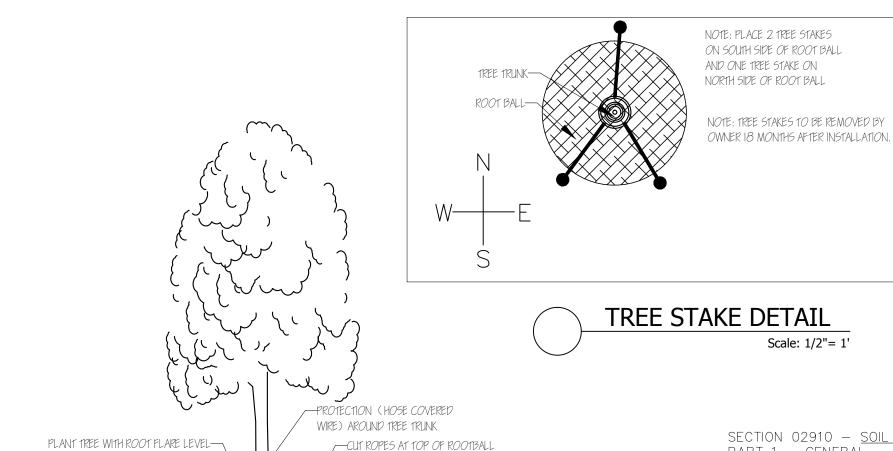

REMOVE TOP 1/3 OF BURLAP

NON-BIODEGRADABLE MATERIAL

AND ALL WIRE AND OTHER

Scale: Not to scale

FLEXBASE MATERIAL

COMPACT TO 2"

DECOMPOSED GRANITE

/ 5.5" LOOSE MATERIAL

COMPACT TO 4"

COMPACTED SUBGRADE

Scale: 1/2"= 1'

1/4" CROSS

SLOPE, NOT TO

WITH FINISHED GRADE

2X ROOT BALL WIDTH

PARKING LOT CURB-

TREE PLANTING


FORM SAUCER WITH 41-

EXISTING TOPSOIL

TREE STAKE KIT, TYP.

BACKFILL WITH ORIGINAL SOIL, WATER—

THOROUGHLY TO REMOVE AIR POCKETS

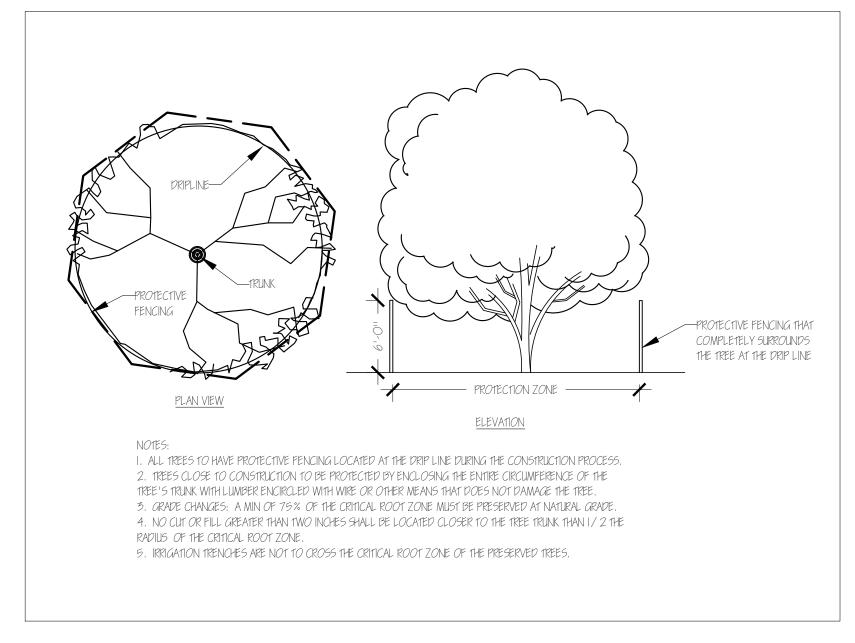





PROVIDE COMPLETE GRADING AND SOIL PREPARATION, INCLUDING AMENDMENTS, AS SPECIFIED HEREIN.

EXAMINE SITE TO VERIFY REQUIRED ROUGH GRADING HAS BEEN COMPLETED CORRECTLY PRIOR TO BED PREPARATION WORK. EXAMINE SITE TO VERIFY THAT ALL INVASIVE PLANTS AND THEIR ROOTS HAVE BEEN REMOVED PRIOR TO BED REPARATION WORK.

1. ALL 'APPROVED EQUAL' MATERIALS MUST BE APPROVED BY LANDSCAPE

ARCHITECT. PART 2 - PRODUCTS

A. MATERIALS COMPOST:

1.1. COTTON BUR COMPOST

1.2. SHALL BE SUPPLIED BY: GREENSENSE COMPOST, GARLAND, TX. OR, CLEAR FORK MATERIALS, ALEDO, TX, OR APPROVED EQUAL.

FERTILIZERS AND SUPPLEMENTS: 2.1. A 6-2-4 GRANULAR FERTILIZER WITH A WATER SOLUBLE SLOW RELEASE ORGANIC BASE SUCH AS GREENSENSE, OR SUSTANE. OR APPROVED EQUAL.

3.1. SHALL BE SHREDDED HARDWOOD MULCH. SHREDDED CEDAR MULCH. SHREDDED NATIVE MULCH, OR APPROVED EQUAL.

PART 3 - EXECUTION

A. BED PREPARATION AND PREPARATION FOR SOD INSTALLATION

 GENERAL 1.1. INSPECT ALL EXISTING CONDITIONS AND OTHER ITEMS OF WORK PREVIOUSLY COMPLETED. DO NOT PROCEED UNTIL DEFECTS ARE

1.2. INSPECT THAT ALL INVASIVE PLANTS AND THEIR ROOTS HAVE BEEN REMOVED COMPLETELY. 1.3. ALL AREAS TO BE PREPARED WITH ORGANIC TECHNIQUES ONLY.

2. SHRUB BEDS: 2.1. BREAK UP AND TILL EXISTING SOIL TO A DEPTH OF 6 INCHES,

2.2. ADD A 3 INCH LAYER OF COMPOST TO THE BEDS, 2.3. TILL EXISTING SOIL AND COMPOST TOGETHER TO A TOTAL OVERALL

2.4. RAKE OUT ROCKS AND CLODS AND FINE GRADE THE BEDS TO DRAIN IN APPROPRIATE DIRECTIONS.

2.5. TOP-DRESS BED WITH A 3 INCH LAYER OF MULCH AFTER PLANTING. 3. SOD AND SEED AREAS

3.1. LIGHTLY CULTIVATE COMPACTED SOIL AND RAKE THE SOIL SMOOTH.

3.2. ADD 1/3 INCH COMPOST TO ALL AREAS. 3.3. FINE GRADE TO DRAIN IN APPROPRIATE DIRECTIONS.

#### END OF SECTION 02910

GENERAL LANDSCAPE

DEPTH OF 8 INCHES.

1. LANDSCAPE CONTRACTOR IS RESPONSIBLE FOR LOCATING ALL UNDERGROUND UTILITIES AND STRUCTURES WHETHER OR NOT SHOWN ON THE PLANS, AND SHALL BE RESPONSIBLE FOR DAMAGE TO SAID UTILITIES OR STRUCTURES CAUSED BY HIS/HER CREW AND SUBCONTRACTORS.

2. NO PLANTING TO TAKE PLACE UNTIL OWNER HAS INSPECTED AND APPROVED THE BED PREPARATION.

3. NO PLANTING TO TAKE PLACE UNTIL OWNER HAS INSPECTED AND APPROVED ALL PLANT MATERIAL AND ALL PLANT PLACEMENT. FIELD ADJUSTMENTS OF PLANT LOCATIONS TO BE COORDINATED WITH OWNER.

4. ALL CANOPY AND ORNAMENTAL TREES TO BE STAKED (SEE DETAIL.)

5. BOULDERS AND NATURAL ROCK MATERIAL USED IN BEDS AND SHALL BE REVIEWED BY THE OWNER'S REPRESENTATIVE PRIOR TO INSTALLATION. CONTRACTOR ASSUMES FULL RESPONSIBILITY FOR FAILURE TO OBTAIN OWNERS REVIEW OF THE ROCK QUALITY AND POSITIONING AND IS RESPONSIBLE FOR ANY MODIFICATIONS REQUIRED. ALL BOULDERS TO BE 'PLANTED' A MINIMUM OF 4 INTO THE PLANTING BEDS.

6. ALL LAWN AND LANDSCAPE BED AREAS ARE TO BE SEPARATED BY 14 GAUGE EDGING UNLESS OTHERWISE NOTED ON THE PLANS.

SECTION 02915 - LANDSCAPE PLANTING PART 1 — GENERAL

A. SPECIAL CONDITIONS 1. COMPLY WITH APPLICABLE FEDERAL, STATE, COUNTY AND LOCAL REGULATIONS GOVERNING LANDSCAPE MATERIALS AND WORK. 2.EMPLOY ONLY EXPERIENCE PERSONNEL FAMILIAR WITH REQUIRED WORK PROVIDE ADEQUATE SUPERVISION BY A QUALIFIED FOREMAN WITH A MINIMUM OF TEN(10) YEARS EXPERIENCE WITH PROJECTS OF SIMILAR

COMPLEXITY. REQUIRED MATERIAL IS NOT OBTAINABLE, SUBMIT PROOF OF

NON-AVAILABILITY TO OWNER'S REPRESENTATIVE. 4.PROVIDE QUANTITY, SIZE, GENUS, SPECIES AND VARIETY OF TREES AND SHRUBS INDICATED AND SCHEDULED FOR LANDSCAPE WORK WHICH COMPLY WITH APPLICABLE REQUIREMENTS OF ANSI Z60.1 AMERICAN STANDARD FOR NURSERY STOCK, AND ANY APPLICABLE STATE AND FEDERAL LAWS CONCERNING DISEASE AND INSECT INFESTATION.

B.REFERENCE STANDARDS 1. AMERICAN STANDARD FOR NURSERY STOCK, APPROVED NOV. 6, 1996 BY AMERICAN NATIONAL STANDARDS INSTITUTE, INC. 2. SHINNERS & MAHLER'S, ILLUSTRATED FLORA OF NORTH CENTRAL TEXAS, BOTANICAL RESEARCH INSTITUTE OF TEXAS (BRIT), FORT WORTH, TEXAS,

3. HORTUS THIRD, CORNELL UNIVERSITY, 1967. C.PREPARATION

ADEQUATE ROOT DEVELOPMENT.

4.COORDINATION WITH BUILDING AND ENGINEERING PROJECT ACTIVITIES. 5.COORDINATE THE WORK OF THIS SECTION WITH THAT OF REGULAR AND EMERGENCY WATER UTILITY ACTIVITIES ON THE SITE. 6. COORDINATION WITH IRRIGATION SYSTEM:

6.1. THE UNDERGROUND IRRIGATION SYSTEM MUST BE INSTALLED PRIOR TO COMMENCEMENT OF THE PLANTING OPERATIONS. 6.2. THE IRRIGATION SYSTEM SHALL BE OPERATIONAL AT THE TIME THAT PLANTING OPERATIONS COMMENCE.

6.3. COORDINATE WORK WITH THE IRRIGATION CONTRACTOR TO PREVENT DAMAGE TO THE IRRIGATION SYSTEM.

D.ALL PLANT MATERIALS FOR THIS PROJECT SHALL BE NURSERY-GROWN, INCLUDING TREES. 1. CONTAINER GROWN PLANTS SHALL HAVE BEEN STEPPED-UP AS

NECESSARY TO PREVENT ROOT GIRDLING. 2.CONTAINER GROWN PLANTS SHALL HAVE BEEN IN THE CONTAINER FOR A MINIMUM OF SIX (6) MONTHS PRIOR TO DELIVERY TO THE SITE TO ENSURE

3. THE 'ROOT FLARE' OF ALL TREES AND SHRUBS SHALL NOT BE COVERED WITH SOIL. E.THE FOLLOWING TREE CARE PROCEDURES SHALL BE ADHERED TO:

1.DO NOT MAKE FLUSH CUTS OR LEAVE STUBS WHEN PRUNING. LEAVE THE BRANCH COLLAR INTACT. 2.DO NOT USE ANY TYPE OF PRUNING PAINT ON WOUNDS.

3.DO NOT USE ANY TYPE OF TREE WRAP, EXCEPT, TRUNKS MAY BE WRAPPED WITH BURLAP DURING PLANTING OPERATIONS ONLY. 4. TREE STAKING MAY BE NECESSARY TO PRESERVE A TREE THAT IS IN A POSITION TO BLOW OVER. THE CONTRACTOR WILL BE RESPONSIBLE FOR ANY TREES THAT NEED STAKING FOR A PERIOD OF ONE YEAR. 5.DO NOT HANDLE ANY TREE BY ITS TRUNK. ANY TREE HANDLED IN SUCH A MANNER SHOULD BE REJECTED.

F. WARRANTEE 1. UNCONDITIONALLY WARRANT ALL PLANTS FOR A PERIOD OF ONE (1) YEAR AFTER THE DATE OF INSTALLATION INITIAL ACCEPTANCE. REPLACE MATERIALS NOT IN VIGOROUS, THRIVING CONDITION AS SOON AS WEATHER PERMITS AFTER NOTIFICATION BY OWNERS THAT THE PLANTS HAVE DIED OR ARE OTHER WISE NOT ACCEPTABLE. GUARANTEE REPLACEMENT PLANTS FOR ONE YEAR, STARTING FROM THE DATE REPLACEMENT IS

2. WARRANTY EXCLUDES REPLACEMENT OF PLANTS BECAUSE OF INJURY BY STORM, NATURAL DROUGHT, DROWNING, HAIL FOR FREEZING, IF REASONABLE CARE WAS TAKEN TO ADEQUATELY PROTECT THE MATERIAL, AND IN THE OPINION OF THE OWNER'S REPRESENTATIVE THAT THE PROBLEM OCCURRED AFTER THE DATE OF INITIAL ACCEPTANCE.

PART 3 - EXECUTION

A. PREPARATION FOR PLANT MATERIAL INSTALLATION 1. EXAMINE THE SUB-GRADE UPON WHICH THE WORK IS TO BE PERFORMED, VERIFY GRADE ELEVATIONS AND VERIFY THAT BEDS HAVE BEEN LEFT LOW BY OTHER TRADES. OBSERVE THE CONDITIONS UNDER WHICH THE WORK IS TO BE PERFORMED AND CONFIRM THAT UNSATISFACTORY CONDITIONS HAVE BEEN CORRECTED PRIOR TO

PROCEEDING. TIME OF PLANTING 1. CARE IS TO BE TAKEN SO THAT NO PLANTS SIT IN POTS IN THE SUMMER HEAT FOR MORE THAN 1 HOUR. IF PLANTING DURING HOT SEASONS (NOT PREFERRED) PLANTING IS TO BE DONE IN SMALL SECTIONS WITH STOCKPILED PLANTS TO BE PROTECTED FROM THE

SUMMER HEAT (SHADE AREAS). TREE PLANTING

1. STAKE LOCATIONS FOR TREES PRIOR TO DIGGING HOLES. 2. DIG PITS WITH ROUGH SIDES AND WHICH HAVE TAPERED WALLS. A MINIMUM OF TWICE THE WIDTH OF THE TREE BALL. A PEDESTAL SHOULD BE LEFT IN THE CENTER OF THE HOLE AND THE TREE BALL SET UPON THAT PEDESTAL.

3. SET PLANTS IN THE CENTER OF THE HOLE AND ON THE PEDESTAL, PLUM AND VERTICAL, AND AT SUCH A DEPTH THAT THE CROWN OF THE

TREE BALL WILL BE LEVEL WITH THE SURROUNDING GRADE. 4. ALL PLANTS SHALL BE SET TO MEET THE SAME RELATIONSHIP TO THE FINISHED GRADE OF THE SURROUNDING SOIL THAT THEY BORE TO PREVIOUS EXISTING GRADE OF SOIL

5. BACKFILL WITH EXISTING TOPSOIL AND WATER IMMEDIATELY. 6. FORM A SHALLOW BASIN SLIGHTLY LARGER THAN THE PIT TO FACILITATE WATERING. REMOVE PRIOR TO MULCHING.

7. COVER ALL TREE BALLS WITH A MINIMUM OF 3 OF SPECIFIED MULCH. EXTEND MULCH OUT TO THE EDGE OF THE TREE PIT, BUT KEEP AWAY FROM TRUNKS.

8. ALL EXCAVATED MATERIAL UNACCEPTABLE FOR REUSE SHALL BE DISPOSED OF OFF SITE, OR AS DIRECTED BY THE OWNER.

SHRUBS, TALL GRASSES AND PERENNIAL PLANTING. 1. REMOVE CONTAINER AND SET PLANT MATERIAL AT SUCH A LEVEL THAT AFTER SETTLEMENT, THE CROWN OF THE BALL WILL BE AT FINISHED

POT-BOUND PRIOR TO INSTALLATION. 3. COVER PLANTING BEDS WITH A MINIMUM 3 LAYER OF SPECIFIED MULCH.

2. GENTLY CUT OUTER ROOTS OF ANY ROOTBALLS THAT HAVE

SOD PLANTING 1. LAY SOD IN AN ORDERLY MANNER TO COVER ALL BARE SOIL AREAS. 2. WATER ALL AREAS OF THE SOD UNTIL THOROUGHLY WET.

3. ROLL SOD WITH A SOD ROLLER AFTER 24 HOURS AFTER LAYING AND WATERING SOD TO OBTAIN A UNIFORM, SMOOTH FINISH. 4. FILL JOINTS WITH COMPOST IF NECESSARY TO FORM A UNIFORM GRASS

5. KEEP SOD ADEQUATELY WATERED UNTIL SOD MAKES A FIRM CONNECTION TO THE SOIL.

END OF SECTION 02915


### **Owner & Professionals Information**

OWNER TURBO RESTAURANTS 3318 FOREST LANE, #200, DALLAS, TX 75234 214-551-0921

**ENGINEER** ARTEC LLC 6800 WEISKOPF AVE, SUITE 150, McKINNEY, TEXAS 75070 TBPE ENGINEERING FIRM F-16272972-731-2930

LANDSCAPE ARCHITECT FELDMAN DESIGN STUDIOS RICHARDSON, TEXAS 75083 ATTN: CAROL FELDMAN, 972-980-1730

**ZONING CASE ZC 2016-02** LANDSCAPE DETAILS

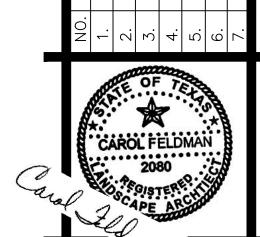

These draw been prepared y or under the supervision of Carol Feldman, Registered Landscape Architect #2080, Licensed Irrigator LI #20245





JRAN-ROAD ILLS, TE PLAN PE 4 C S 

SHEET NO.


Z

4

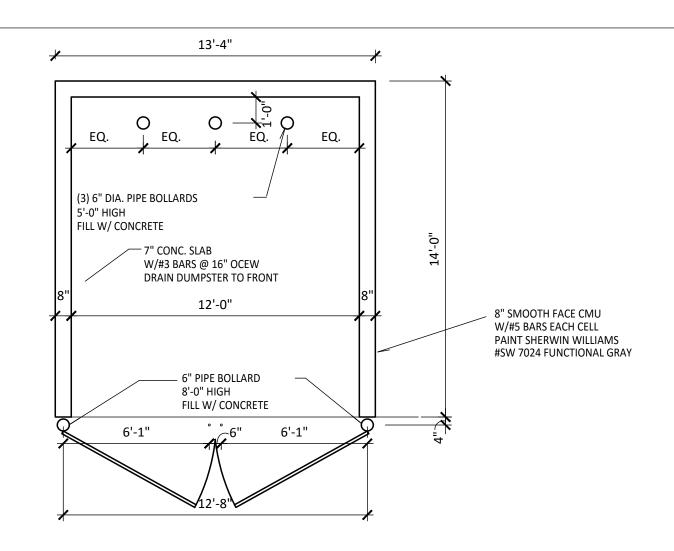

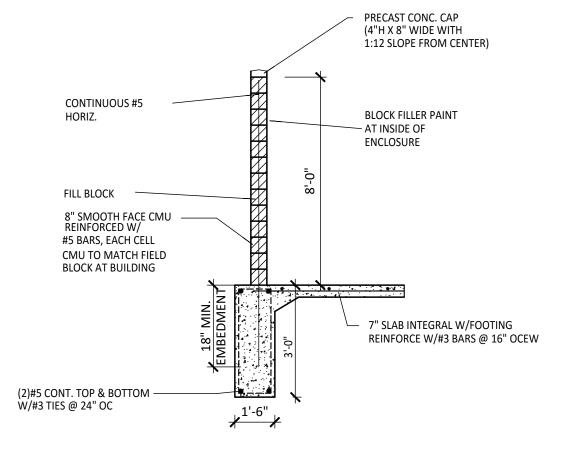

**DUMPSTER WALL SECTION** 

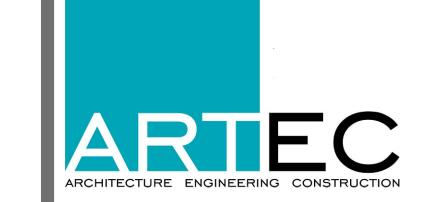


THE SEAL APPEARING ON THIS DOCUMENT WAS AUTHORIZED BY JORDAN M REY, PE 117211 ON 1/29/2016

ARTEC LLC
6800 WEISKOPF AVE
SUITE 150
McKINNEY, TEXAS 75070
TBPE ENGINEERING FIRM F-16272
TBAE ARCHITECTURAL FIRM BR 1707
www.theartecedge.com
214.721.0732



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#### ARBY'S RESTAURANT GROUP LOT 2, BLOCK 1

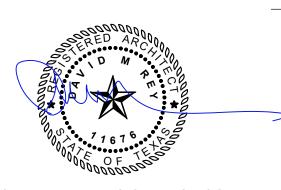WAL-MART ADDITION KNOWN AS 8245 PRECINCT LINE ROAD NORTH RICHLAND HILLS, TEXAS 76182

TURBO RESTAURANTS
3318 FOREST LANE, SUITE 200
DALLAS, TEXAS 75234

PROJECT ISSUE DATES

ARTEC PROJECT NO. CLIENT PROJECT NO. FILE NO. 16-1110

REVISIONS DATE DESCRIPTION

PROJECT ORIENTATION

Y CHECKED BY MANAGE JR JR

CASE ZC 2016-02


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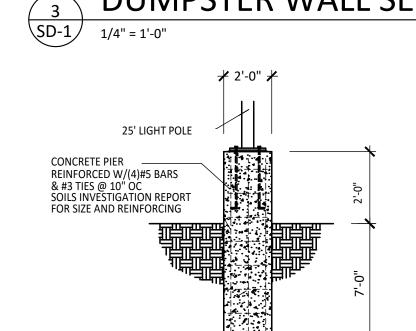
SD-1




SD-1 1/4" = 1'-0"

NOTE: PROVIDE DOUBLE WIDTH DUMPSTER AT LOCATIONS REQUIRING RECYCLING CENTER



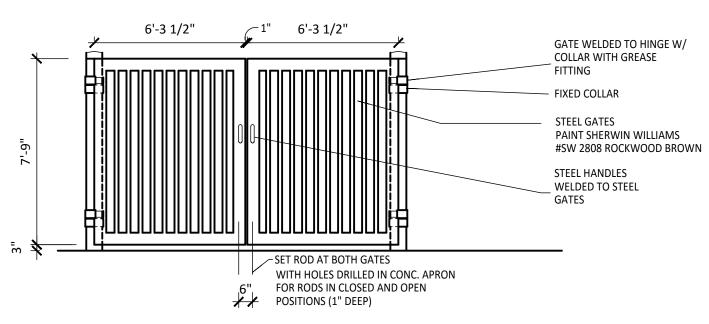

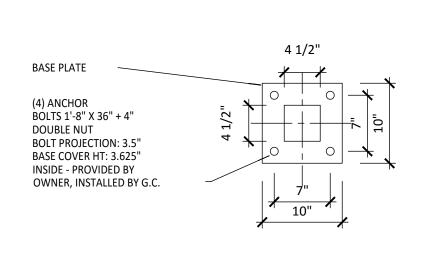

LIGHT POLE BASE

| SD-1 | 1/4" = 1'-0"



DUMPSTER ELEVATION

1/4" = 1'-0"

